

LEGEND


PROPOSED PIPELINE EXISTING PIPELINE PROPERTY LINE STRUCTURE ELEC CABLE FENCE _x---x--x--x--x---x---x---TREE LINE FIBER OPTIC LINE POWER LINES TELEPHONE CABLE TELEPHONE LINE CABLE LINE SILT FENCE PROPOSED EDGE OF ROAD


CONNECTICUT TEMPORARY ACCESS ROAD 1 - PROFILE


GENERAL NOTES


- CHECK DAMS SHALL BE INSTALLED WITHIN ALL SWALES IN ACCORDANCE WITH THE KINDER MORGAN BMP FIGURE NO. 22.
 REFER TO KINDER MORGAN CONSTRUCTION BEST MANAGEMENT PRACTICE MANUAL AND SHEETS TITLED "EROSION AND SEDIMENTATION NOTES," "GENERAL SEEDING NOTES," AND "RECYCLING AND DISPOSAL PLAN," FOR SPECIFIC INSTALLATION AND MAINTENANCE SPECIFICATIONS, AND EROSION CONTROLS.
- 3. PROPOSED TRUCK PULL OFF ARE TEMPORARY AND SHALL BE REMOVED AFTER CONSTRUCTION. THE PULL OFF AREA SHALL BE REGRADED TO MATCH PRE CONSTRUCTION CONTOURS WHERE PRACTICAL. ALL PROPOSED PERMANENT SWALES AND ASSOCIATED CHECK DAMS SHALL BE REMOVED AND REINSTALLED ALONG THE
- PROPOSED EDGE OF ROAD.

 4. THE CONTRACTOR SHALL VERIFY ALL EXISTING CONDITIONS PRIOR TO CONSTRUCTION. THE CONTRACTOR SHALL IMMEDIATELY NOTIFY KINDER MORGAN. INC. AND/OR ITS ENGINEER OF ANY CONDITIONS THAT VARY FROM WHAT IS DEPICTED ON THIS PLAN.
- THE CONTRACTOR SHALL CONTACT CALL BEFORE YOU DIG CONNECTICUT (1-800-922-4455) A MINIMUM OF 72 HOURS PRIOR TO COMMENCEMENT OF CONSTRUCTION.
- 6. ALL SLOPES THAT ARE EQUAL TO OR STEEPER THAN 1(V): 3(H)
 SHALL BE SEEDED AND THEN COVERED WITH EROSION CONTROL
 MATTING PER KINDER MORGAN BMP NO. 41. THE MATTING SHALL BE
 INTERLOCKING TIMBER MATS OR APPROVED EQUAL AND INSTALLED IN
 ACCORDANCE WITH THE MANUFACTURERS SPECIFICATIONS. SEE
 DETAIL IN THE CONSTRUCTION BEST MANAGEMENT PRACTICES.
- 7. ALL SLOPES THAT ARE STEEPER THAN 1(V): 2(H) SHALL BE COVERED WITH RIPRAP SLOPE PROTECTION. SEE SLOPE PROTECTION DETAIL FOR INSTALLATION GUIDELINES IN THE CONSTRUCTION BEST MANAGEMENT PRACTICES.
- 8. CONSTRUCTION ENTRANCES ARE TO BE CONSTRUCTED ON TEMPORARY ACCESS ROADS IF EXCESSIVE SEDIMENT IS CONVEYED ONTO THE MAIN TRAVEL WAY.

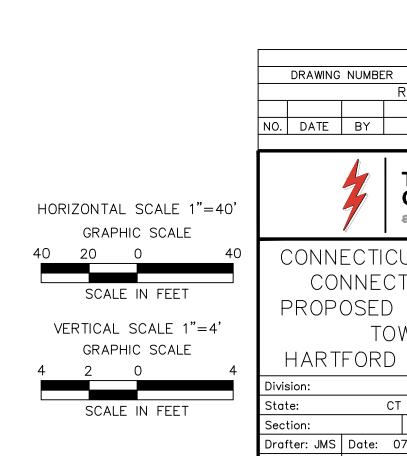

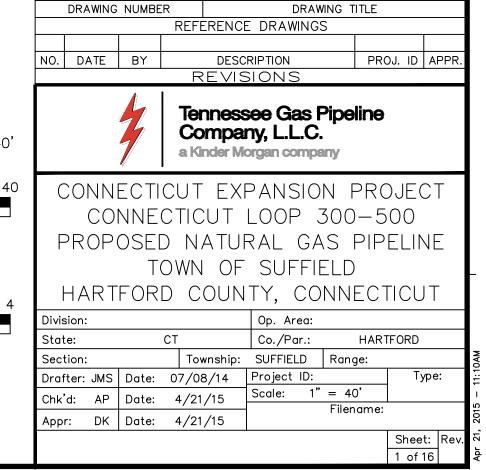

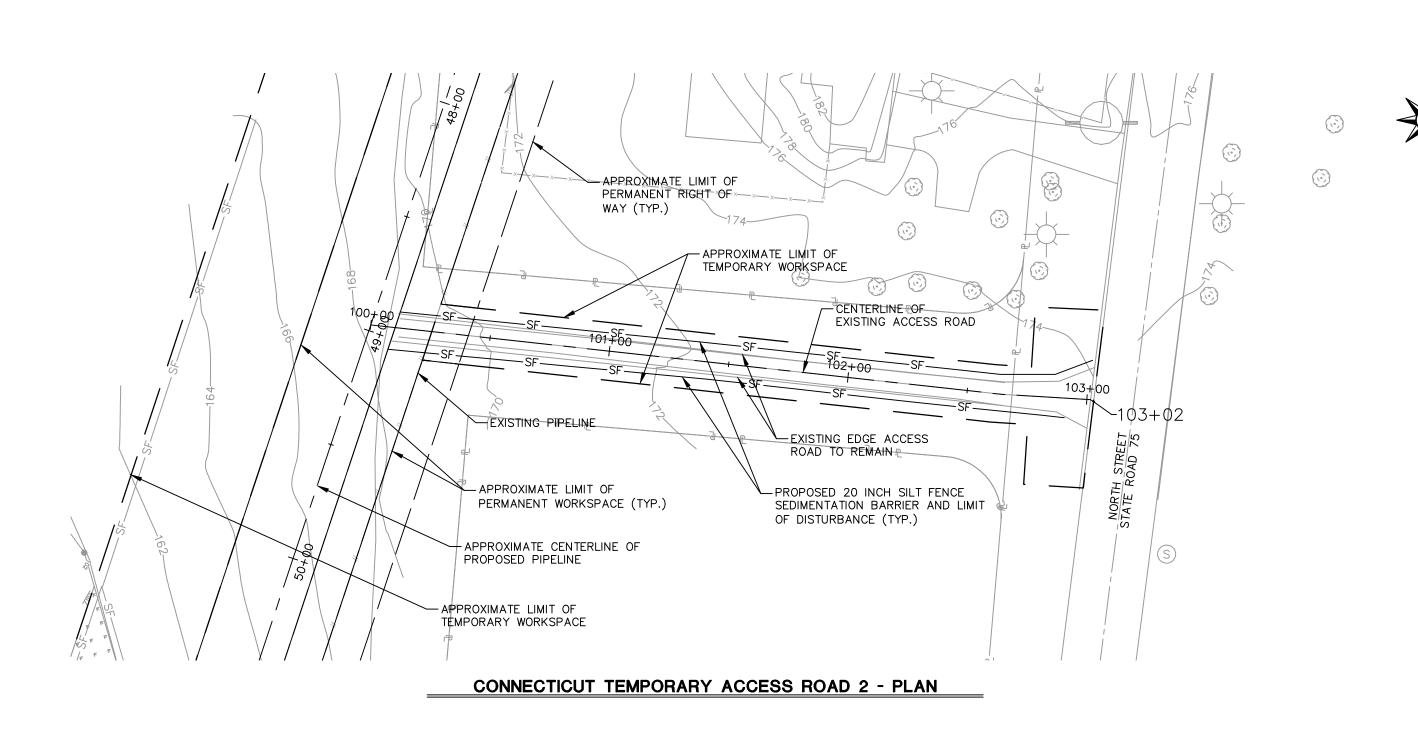

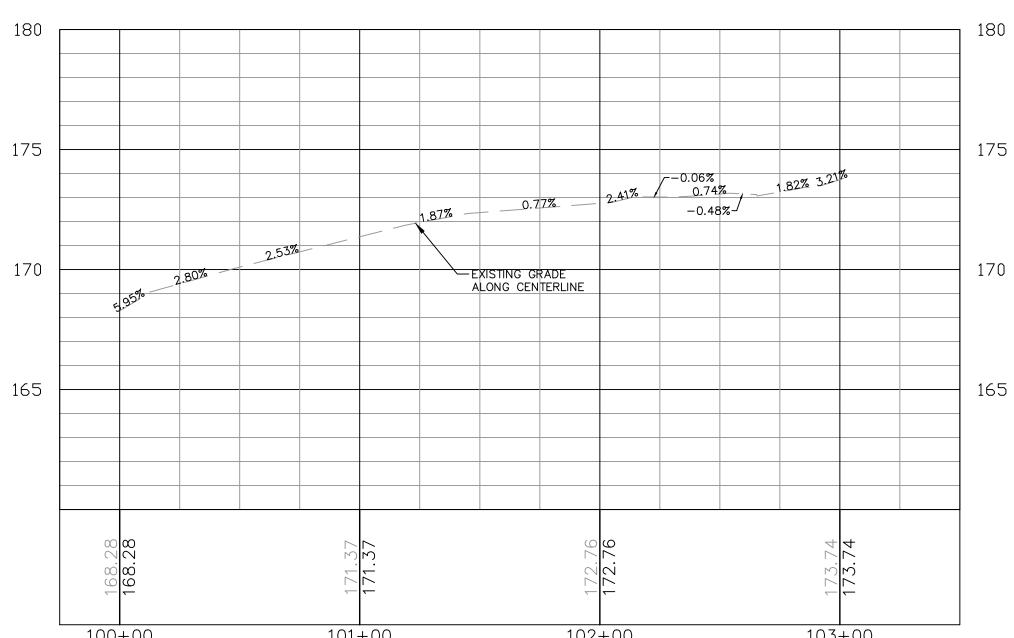

LEGEND


PROPOSED PIPELINE EXISTING PIPELINE PROPERTY LINE STRUCTURE FENCE _X---X---X---X---X---X---TREE LINE FIBER OPTIC LINE POWER LINES TELEPHONE CABLE TELEPHONE LINE CABLE LINE SILT FENCE PROPOSED EDGE OF ROAD

PROPOSED SILT FENCE
——SF——SF——

GENERAL NOTES


- CHECK DAMS SHALL BE INSTALLED WITHIN ALL SWALES IN ACCORDANCE WITH THE KINDER MORGAN BMP FIGURE NO. 22. 2. REFER TO KINDER MORGAN CONSTRUCTION BEST MANAGEMENT PRACTICE MANUAL AND SHEETS TITLED "EROSION AND SEDIMENTATION NOTES," "GENERAL SEEDING NOTES," AND "RECYCLING AND DISPOSAL PLAN," FOR SPECIFIC INSTALLATION AND
- MAINTENANCE SPECIFICATIONS, AND EROSION CONTROLS.

 3. PROPOSED TRUCK PULL OFF ARE TEMPORARY AND SHALL BE REMOVED AFTER CONSTRUCTION. THE PULL OFF AREA SHALL BE REGRADED TO MATCH PRE CONSTRUCTION CONTOURS WHERE PRACTICAL, ALL PROPOSED PERMANENT SWALES AND ASSOCIATED CHECK DAMS SHALL BE REMOVED AND REINSTALLED ALONG THE PROPOSED EDGE OF ROAD.
- 4. THE CONTRACTOR SHALL VERIFY ALL EXISTING CONDITIONS PRIOR TO CONSTRUCTION. THE CONTRACTOR SHALL IMMEDIATELY NOTIFY KINDER MORGAN. INC. AND/OR ITS ENGINEER OF ANY CONDITIONS THAT VARY FROM WHAT IS DEPICTED ON THIS PLAN.
- 5. THE CONTRACTOR SHALL CONTACT CALL BEFORE YOU DIG CONNECTICUT (1-800-922-4455) A MINIMUM OF 72 HOURS PRIOR TO COMMENCEMENT OF CONSTRUCTION.
- 6. ALL SLOPES THAT ARE EQUAL TO OR STEEPER THAN 1(V): 3(H) SHALL BE SEEDED AND THEN COVERED WITH EROSION CONTROL MATTING PER KINDER MORGAN BMP NO. 41. THE MATTING SHALL BE INTERLOCKING TIMBER MATS OR APPROVED EQUAL AND INSTALLED IN ACCORDANCE WITH THE MANUFACTURERS SPECIFICATIONS. SEE DETAIL IN THE CONSTRUCTION BEST MANAGEMENT PRACTICES.
- 7. ALL SLOPES THAT ARE STEEPER THAN 1(V): 2(H) SHALL BE COVERED WITH RIPRAP SLOPE PROTECTION. SEE SLOPE PROTECTION DETAIL FOR INSTALLATION GUIDELINES IN THE CONSTRUCTION BEST MANAGEMENT PRACTICES.
- 8. CONSTRUCTION ENTRANCES ARE TO BE CONSTRUCTED ON TEMPORARY ACCESS ROADS IF EXCESSIVE SEDIMENT IS CONVEYED ONTO THE MAIN TRAVEL WAY.

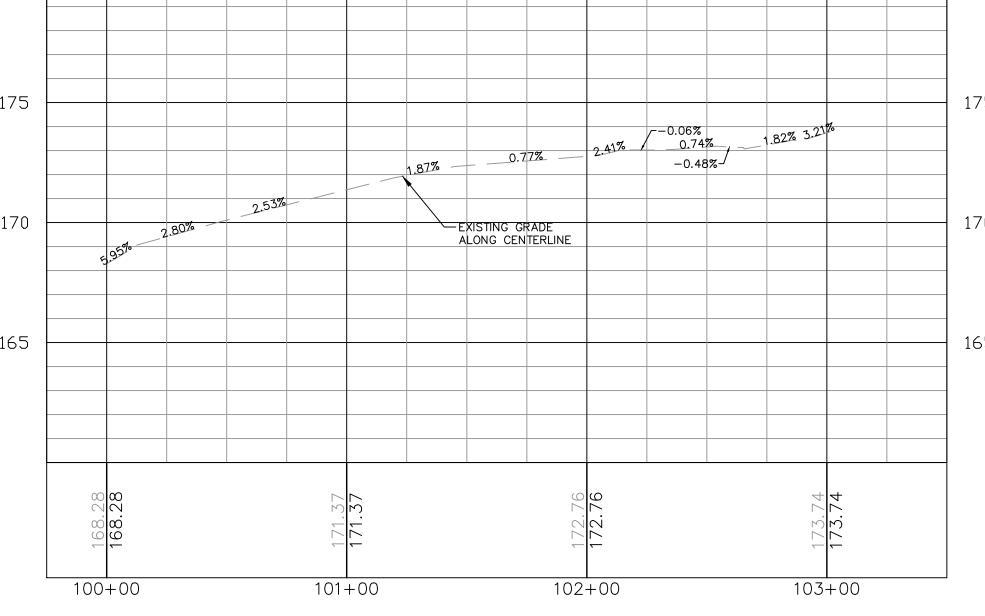


CONNECTICUT TEMPORARY ACCESS ROAD 2 - PROFILE

HORIZONTAL SCALE 1"=40' GRAPHIC SCALE 40 20 0 SCALE IN FEET VERTICAL SCALE 1"=4" GRAPHIC SCALE SCALE IN FEET

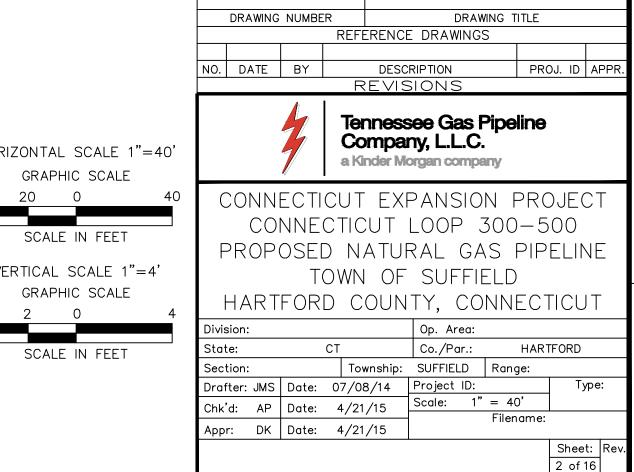

- APPROXIMATE LIMIT OF PERMANENT RIGHT OF - APPROXIMATE LIMIT OF ADDITIONAL TEMPORARY WORKSPACE WAY (TYP.) APPROXIMATE CENTERLINE OF PROPOSED PIPELINE APPROXIMATE LIMIT OF -TEMPORARY WORKSPACE CENTERLINE OF EXISTING ACCESS ROAD -EXISTING EDGE ACCESS ROAD TO REMAIN PROTECT AND MAINTAIN EXISTING CULVERT DURING CONSTRUCTION - APPROXIMATE LIMIT OF PROPOSED 20 INCH SILT FENCE SEDIMENTATION BARRIER AND LIMIT TEMPORARY WORKSPACE ACTIVITIES. SEE KINDER MORGAN BMP OF DISTURBANCE (TYP.) FIGURE NO. 10 IF REQUIRED TO ACCOMMODATE HEAVIER VEHICLE LOADS EXISTING/PIPELINE APPROXIMATE LIMIT OF PERMANENT WORKSPACE (TYP.) CONNECTICUT TEMPORARY ACCESS ROAD 3 - PLAN

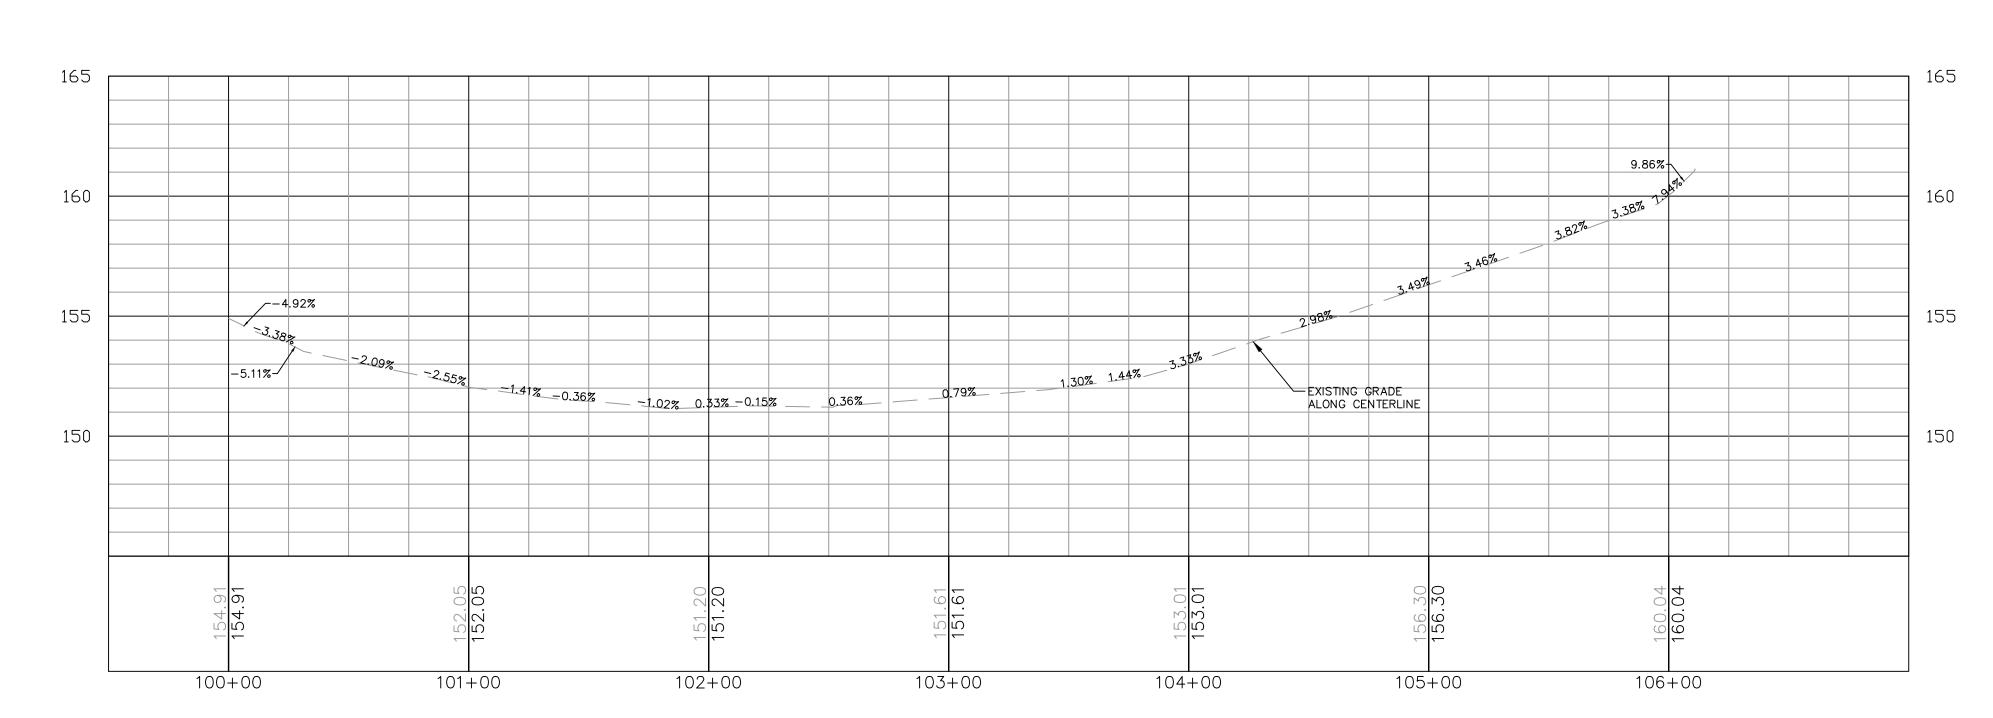

LEGEND

LEGEND

PROPOSED PIPELINE

PROPERTY LINE

EXISTING PIPELINE

STRUCTURE

ELEC CABLE

—— EC ——— EC ——— EC –

TREE LINE

FIBER OPTIC LINE

TELEPHONE LINE

POWER LINES

TELEPHONE CABLE
TC TC TC

CABLE LINE

SILT FENCE

PROPOSED EDGE OF ROAD

CONNECTICUT TEMPORARY ACCESS ROAD 3 - PROFILE

PRACTICE MANUAL AND SHEETS TITLED "EROSION AND SEDIMENTATION NOTES," "GENERAL SEEDING NOTES," AND "RECYCLING AND DISPOSAL PLAN," FOR SPECIFIC INSTALLATION AND MAINTENANCE SPECIFICATIONS, AND EROSION CONTROLS. PROPOSED TRUCK PULL OFF ARE TEMPORARY AND SHALL BE REMOVED AFTER CONSTRUCTION. THE PULL OFF AREA SHALL BE REGRADED TO MATCH PRE CONSTRUCTION CONTOURS WHERE

GENERAL NOTES

PRACTICAL. ALL PROPOSED PERMANENT SWALES AND ASSOCIATED CHECK DAMS SHALL BE REMOVED AND REINSTALLED ALONG THE PROPOSED EDGE OF ROAD.

4. THE CONTRACTOR SHALL VERIFY ALL EXISTING CONDITIONS PRIOR TO CONSTRUCTION. THE CONTRACTOR SHALL IMMEDIATELY NOTIFY

1. CHECK DAMS SHALL BE INSTALLED WITHIN ALL SWALES IN ACCORDANCE WITH THE KINDER MORGAN BMP FIGURE NO. 22.

2. REFER TO KINDER MORGAN CONSTRUCTION BEST MANAGEMENT

KINDER MORGAN. INC. AND/OR ITS ENGINEER OF ANY CONDITIONS
THAT VARY FROM WHAT IS DEPICTED ON THIS PLAN.

5. THE CONTRACTOR SHALL CONTACT CALL BEFORE YOU DIG

CONNECTICUT (1-800-922-4455) A MINIMUM OF 72 HOURS PRIOR TO COMMENCEMENT OF CONSTRUCTION.

6. ALL SLOPES THAT ARE EQUAL TO OR STEEPER THAN 1(V): 3(H)


SHALL BE SEEDED AND THEN COVERED WITH EROSION CONTROL


MATTING PER KINDER MORGAN BMP NO. 41. THE MATTING SHALL BE INTERLOCKING TIMBER MATS OR APPROVED EQUAL AND INSTALLED IN ACCORDANCE WITH THE MANUFACTURERS SPECIFICATIONS. SEE DETAIL IN THE CONSTRUCTION BEST MANAGEMENT PRACTICES.

DETAIL IN THE CONSTRUCTION BEST MANAGEMENT PRACTICES.


7. ALL SLOPES THAT ARE STEEPER THAN 1(V): 2(H) SHALL BE COVERED WITH RIPRAP SLOPE PROTECTION. SEE SLOPE PROTECTION DETAIL FOR INSTALLATION GUIDELINES IN THE CONSTRUCTION BEST MANAGEMENT PRACTICES.


8. CONSTRUCTION ENTRANCES ARE TO BE CONSTRUCTED ON TEMPORARY ACCESS ROADS IF EXCESSIVE SEDIMENT IS CONVEYED ONTO THE MAIN TRAVEL WAY.

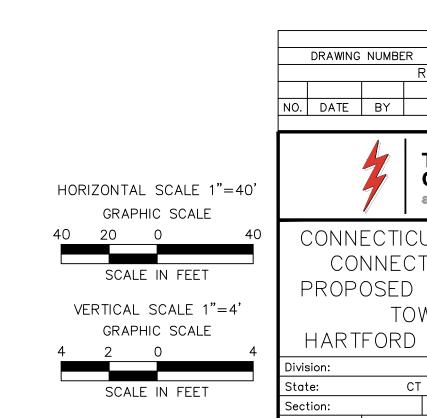

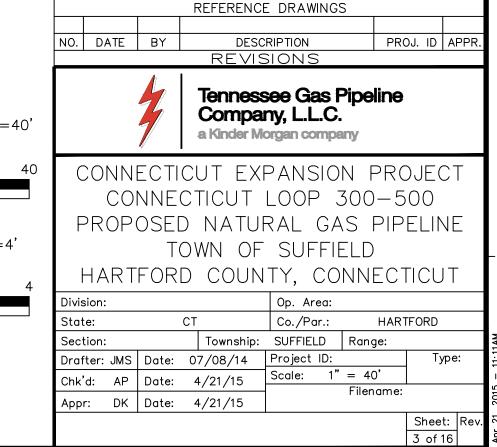

DRAWING TITLE

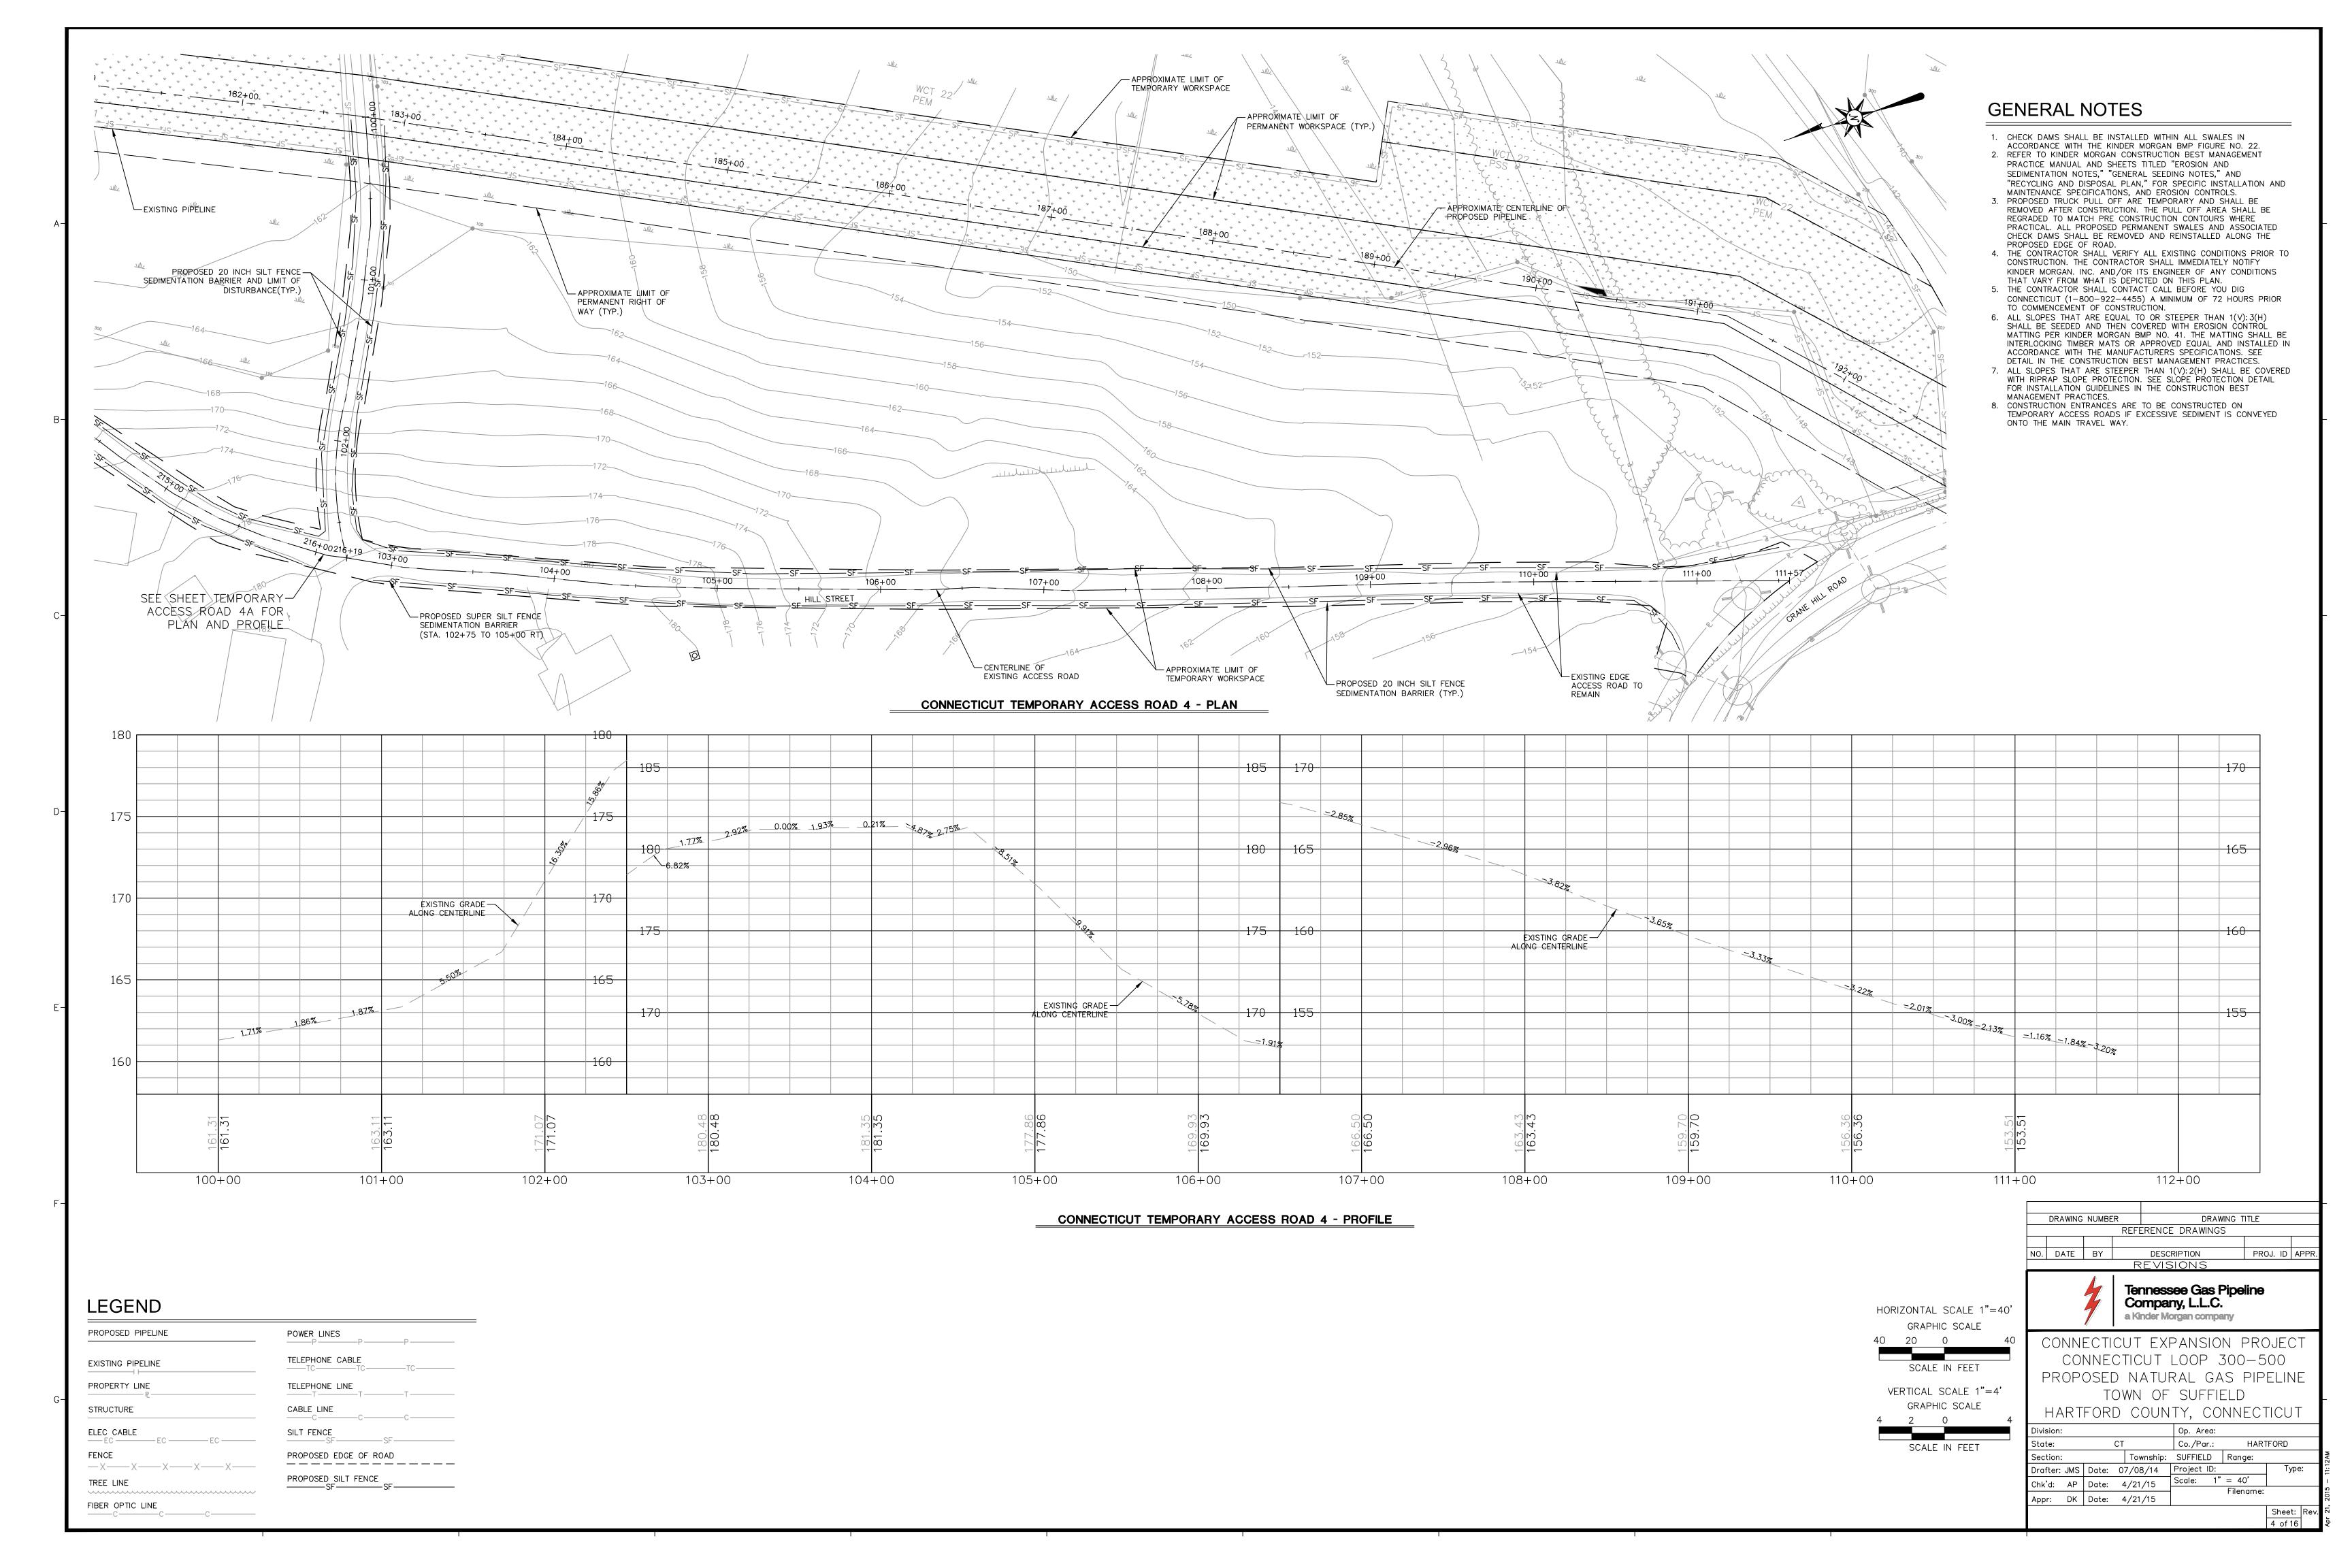

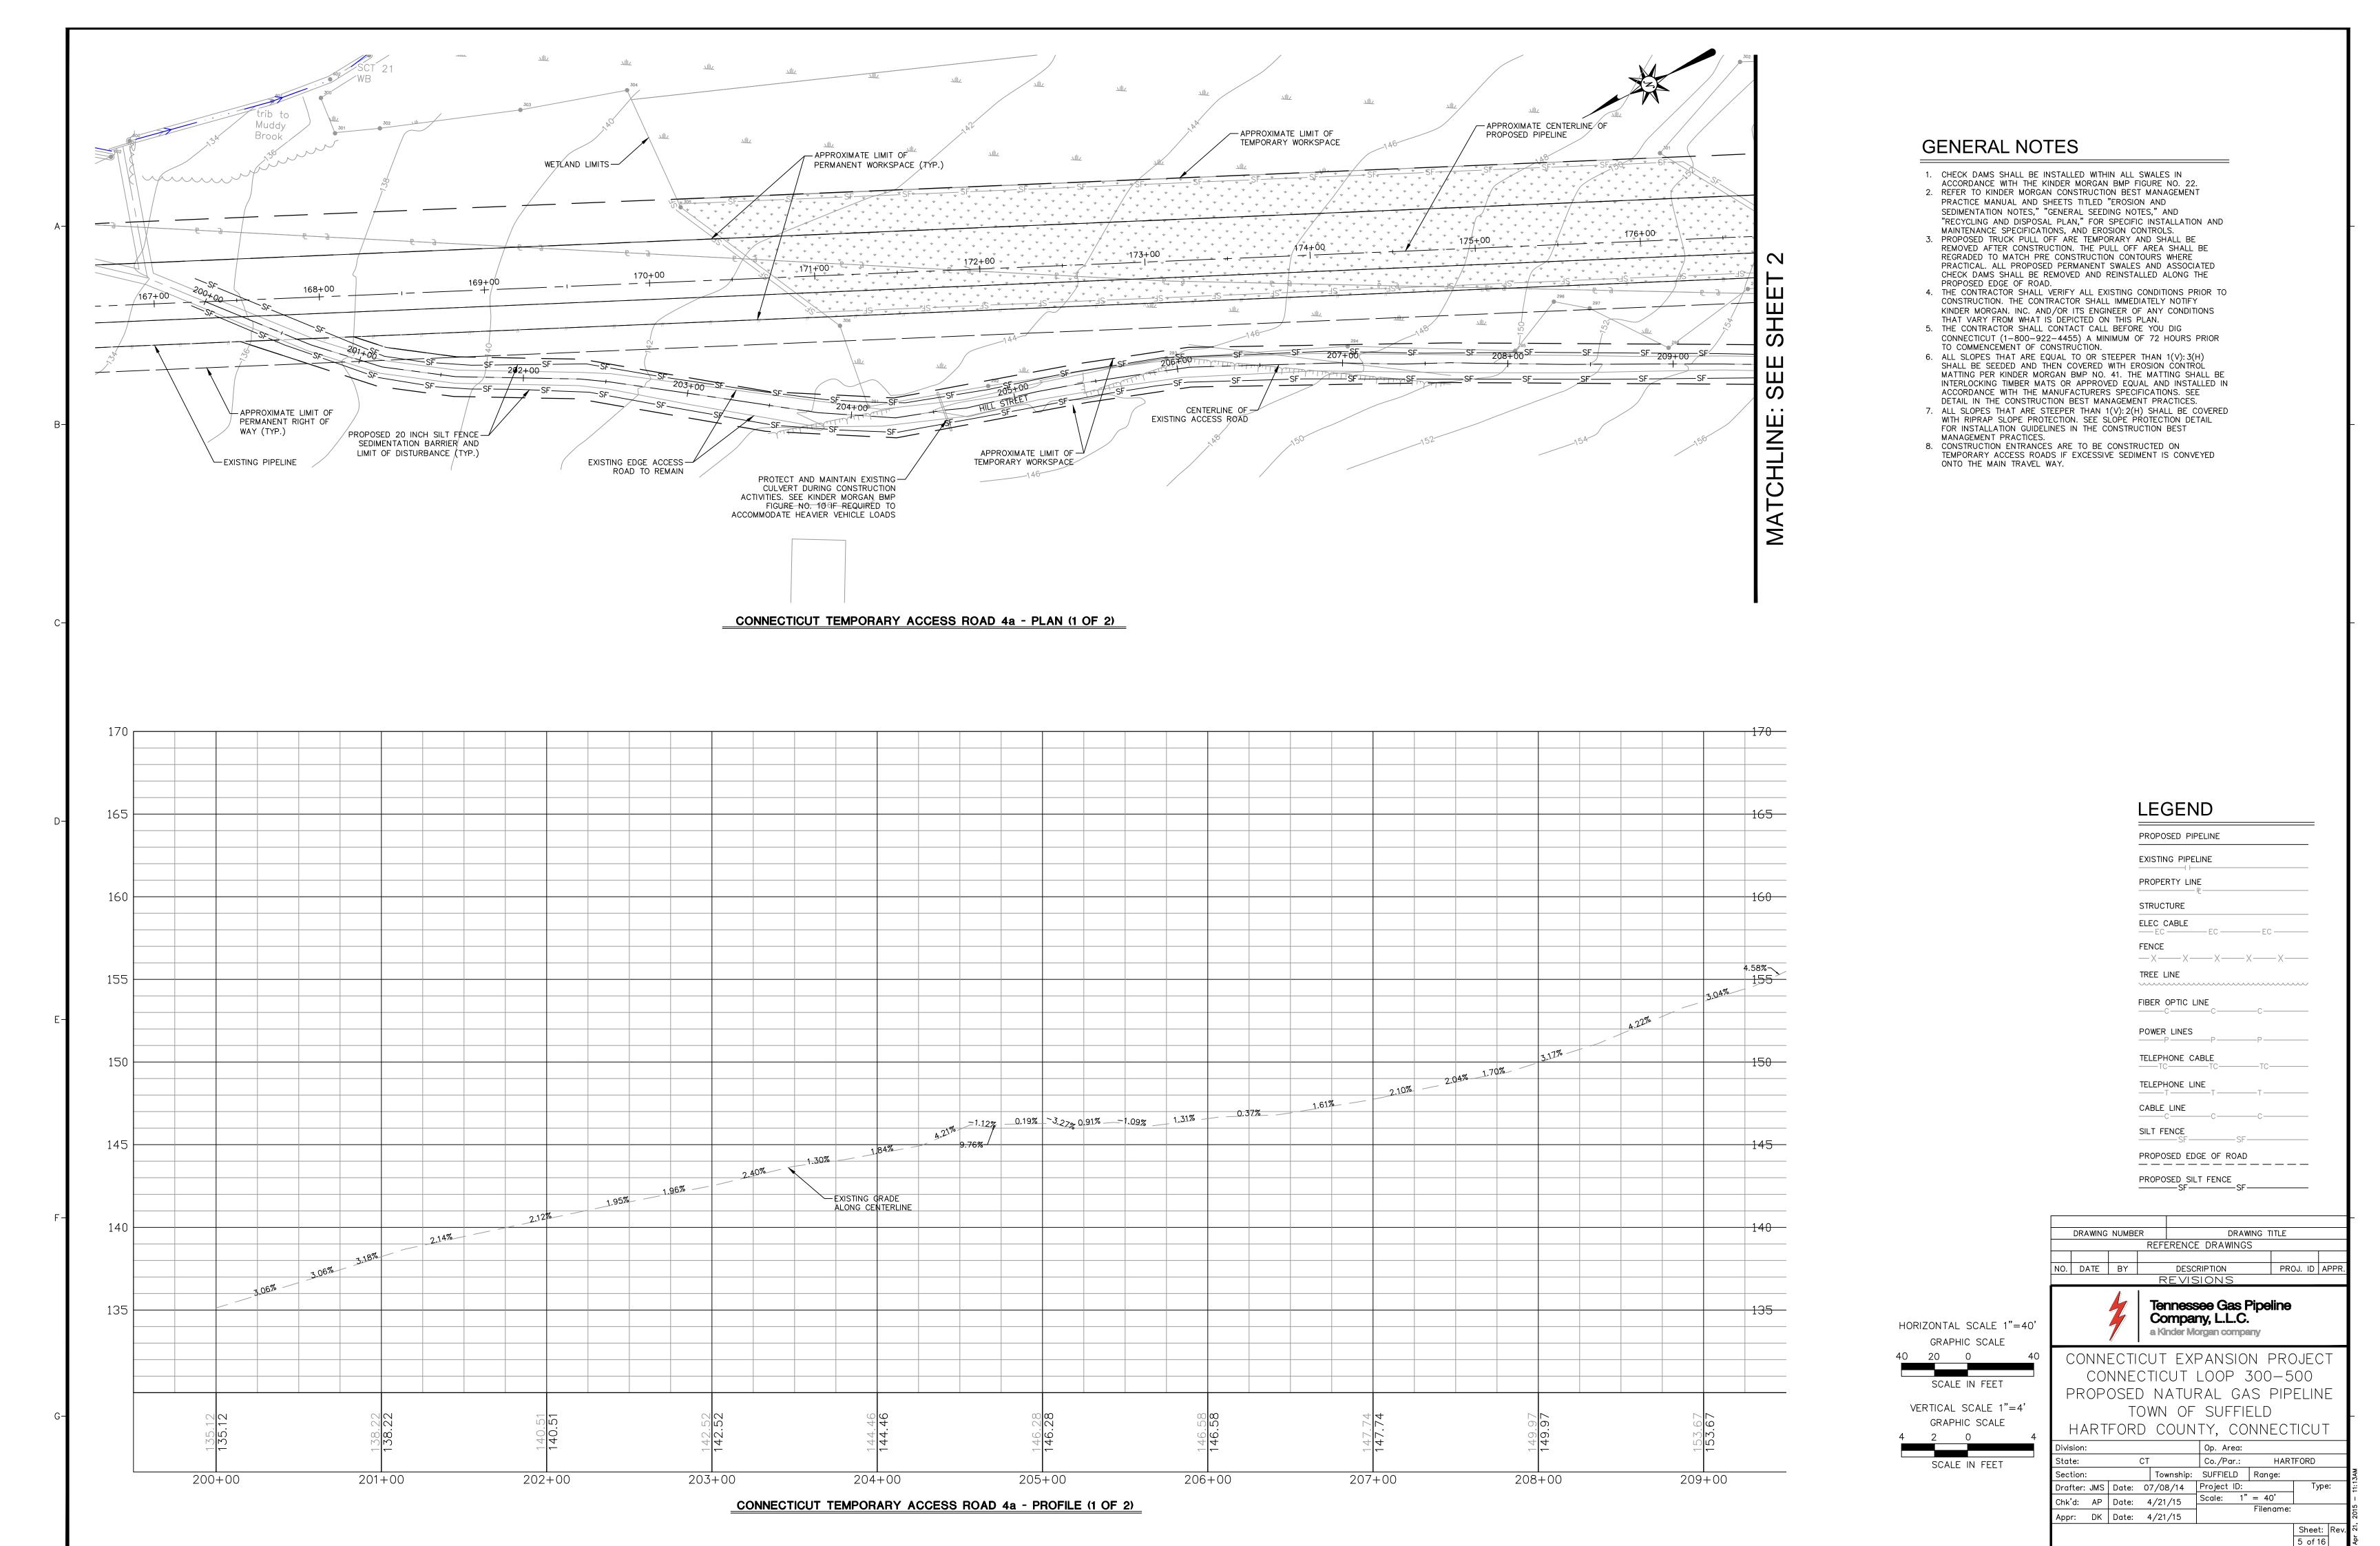

180+00 + 179+ 177+00 APPROXIMATE CENTERLINE OF PROPOSED PIPELINE - EXISTING PIPELINE - APPROXIMATE LIMIT OF PERMANENT/RIGHT OF WAY (TYP.) SH Ш SEE SHEET TEMPORARY 170 S PROPOSED 20 INCH SILT FENCE SEDIMENTATION BARRIER AND LIMIT ACCESS ROAD 4 PLAN AND PROFILE OF DISTURBANCE (TYP.) - CENTERLINE OF APPROXIMATE LIMIT OF -EXISTING ACCESS ROAD TEMPORARY WORKSPACE EXISTING EDGE ACCESS ROAD TO REMAIN 216+00216+19 103+00 CONNECTICUT TEMPORARY ACCESS ROAD 4a - PLAN (2 OF 2)

CONNECTICUT TEMPORARY ACCESS ROAD 4a - PROFILE (2 OF 2)

GENERAL NOTES

- CHECK DAMS SHALL BE INSTALLED WITHIN ALL SWALES IN
 ACCORDANCE WITH THE KINDER MORGAN BMP FIGURE NO. 22.
 REFER TO KINDER MORGAN CONSTRUCTION BEST MANAGEMENT
 PRACTICE MANUAL AND SHEETS TITLED "EROSION AND
 SEDIMENTATION NOTES," "GENERAL SEEDING NOTES," AND
 "RECYCLING AND DISPOSAL PLAN," FOR SPECIFIC INSTALLATION AND
- MAINTENANCE SPECIFICATIONS, AND EROSION CONTROLS.

 3. PROPOSED TRUCK PULL OFF ARE TEMPORARY AND SHALL BE REMOVED AFTER CONSTRUCTION. THE PULL OFF AREA SHALL BE REGRADED TO MATCH PRE CONSTRUCTION CONTOURS WHERE PRACTICAL. ALL PROPOSED PERMANENT SWALES AND ASSOCIATED CHECK DAMS SHALL BE REMOVED AND REINSTALLED ALONG THE PROPOSED EDGE OF ROAD.
- 4. THE CONTRACTOR SHALL VERIFY ALL EXISTING CONDITIONS PRIOR TO CONSTRUCTION. THE CONTRACTOR SHALL IMMEDIATELY NOTIFY KINDER MORGAN. INC. AND/OR ITS ENGINEER OF ANY CONDITIONS THAT VARY FROM WHAT IS DEPICTED ON THIS PLAN.
- 5. THE CONTRACTOR SHALL CONTACT CALL BEFORE YOU DIG CONNECTICUT (1-800-922-4455) A MINIMUM OF 72 HOURS PRIOR TO COMMENCEMENT OF CONSTRUCTION.
- 6. ALL SLOPES THAT ARE EQUAL TO OR STEEPER THAN 1(V): 3(H)
 SHALL BE SEEDED AND THEN COVERED WITH EROSION CONTROL
 MATTING PER KINDER MORGAN BMP NO. 41. THE MATTING SHALL BE
 INTERLOCKING TIMBER MATS OR APPROVED EQUAL AND INSTALLED IN
 ACCORDANCE WITH THE MANUFACTURERS SPECIFICATIONS. SEE
- DETAIL IN THE CONSTRUCTION BEST MANAGEMENT PRACTICES.

 7. ALL SLOPES THAT ARE STEEPER THAN 1(V): 2(H) SHALL BE COVERED WITH RIPRAP SLOPE PROTECTION. SEE SLOPE PROTECTION DETAIL FOR INSTALLATION GUIDELINES IN THE CONSTRUCTION BEST
- MANAGEMENT PRACTICES.

 8. CONSTRUCTION ENTRANCES ARE TO BE CONSTRUCTED ON TEMPORARY ACCESS ROADS IF EXCESSIVE SEDIMENT IS CONVEYED ONTO THE MAIN TRAVEL WAY.

LEGEND

PROPOSED PIPE	LINE	
EXISTING PIPELI		
PROPERTY LINE		
STRUCTURE		
ELEC CABLE ——EC ———	-EC	EC
FENCE	×	-××-
TREE LINE	^	^ ^
FIBER OPTIC LIN	IE —C——	C
POWER LINES	P	P
P		1
TELEPHONE CAR	RI F	тс
TELEPHONE CAE	BLE —TC——	
TELEPHONE CAE TELEPHONE LINE	BLE —TC——— <u>=</u> —T——	тс
TELEPHONE CAE TELEPHONE LINE	BLE —TC——— E —T———	TCT
TELEPHONE CAE TELEPHONE LINE TO CABLE LINE C SILT FENCE	BLE —TC	TC T C

DRAWING TITLE

PROJ. ID APPE

				NO.	D
1100	JZONITA	L COALE 4"	40'		
HOR		L SCALE 1":	=40		
	GRAF	HIC SCALE			
40	20	0	<u>4</u> 0		O(
	SCAL	E IN FEET		I	, D
			.,		'K
VE	-R IICAL	SCALE 1"=	:4		
	GRAF	HIC SCALE		! ⊦	$\dashv \angle$
4	2	0	4	'	17
				Divis	ion
	SCAL	E IN FEET		Stat	e:
				Sect	ion


DESCRIPTION	BY	DATE	NO.
REVISIONS			
Tennessee Gas Pi Company, L.L.C. a Kinder Morgan compan			
CUT EXPANSION	ECTI	CONN	(
CTICLIT LAAD 3/		\cap	


DRAWING NUMBER


CONNECTICUT EXPANSION PROJECT
CONNECTICUT LOOP 300-500
PROPOSED NATURAL GAS PIPELINE
TOWN OF SUFFIELD

REFERENCE DRAWINGS

HA	\RT	FORI	\mathcal{L}	COUN	TY,	CO	NNECT	TICUT	-	
Division:						Op. Area:				
State: CT					Co./Po	ar.:	HARTFORD			
Section:				Township:	SUFFIE	LD	Range:			
Drafter:	JMS	Date:	0	7/08/14	Project			Туре	: :	
Chk'd:	AP	Date:	_	1/21/15	Scale:	1"	= 40'			
Appr:	DK	Date:		1/21/15			Filename:			
								Sheet:	Rev	

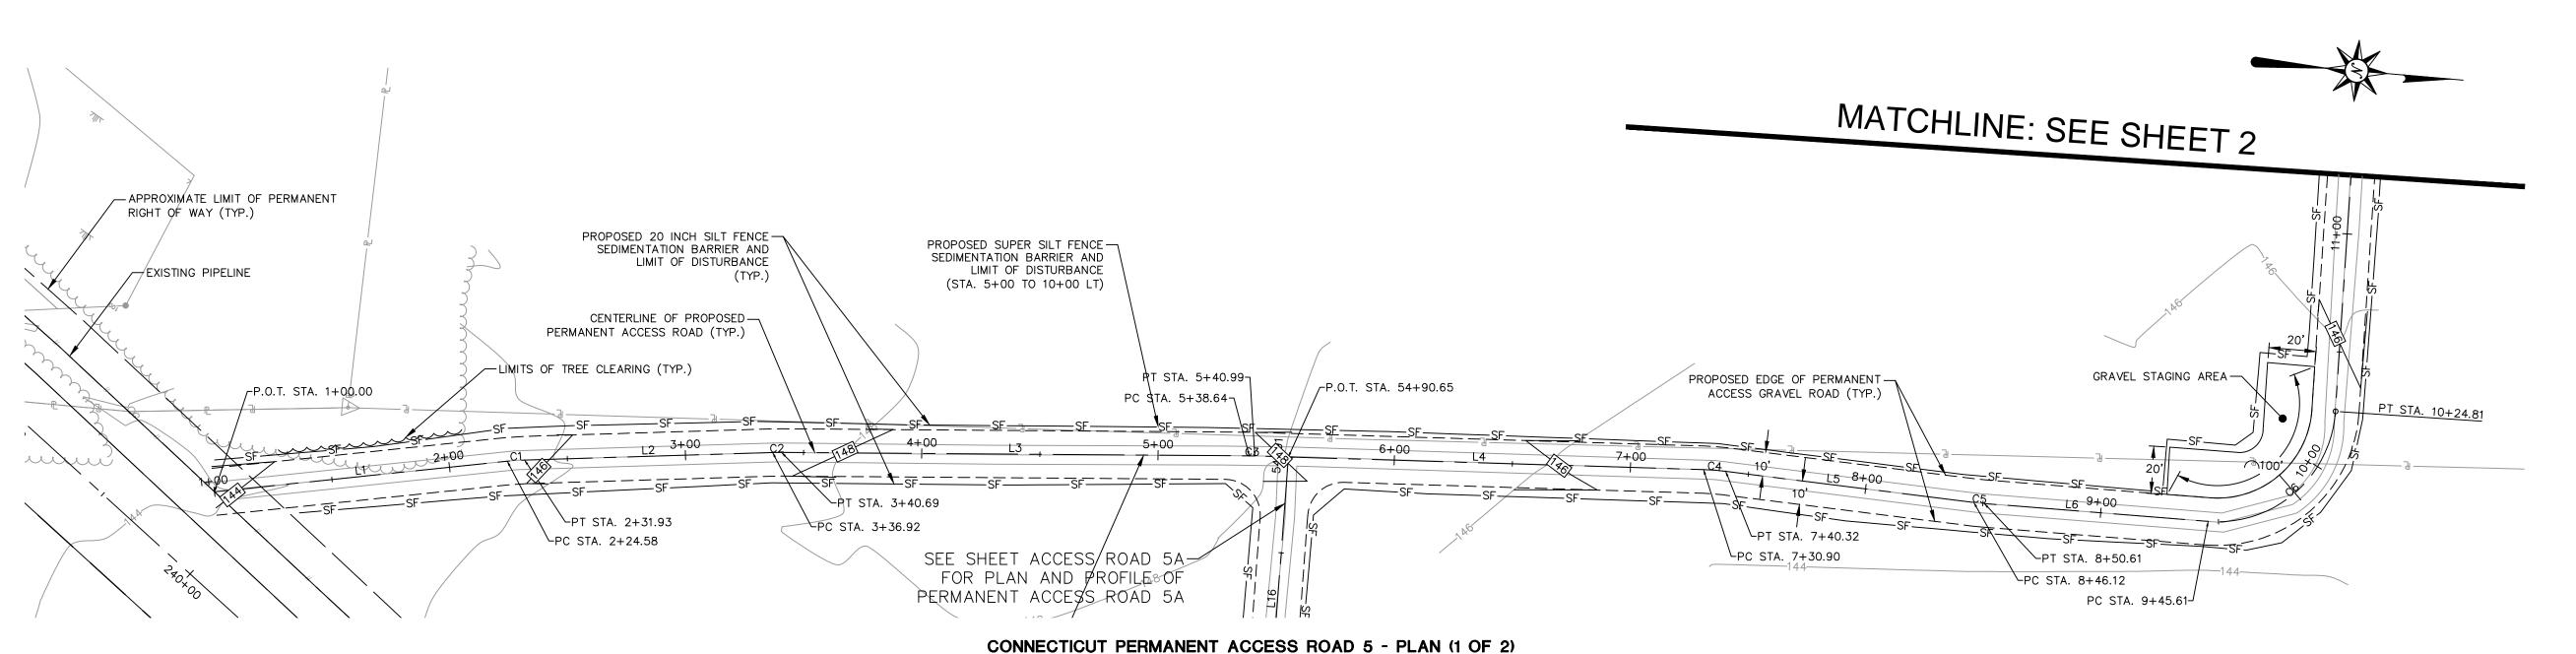

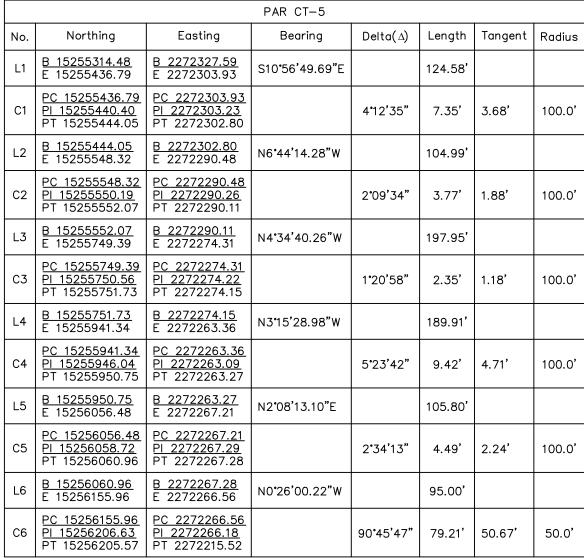

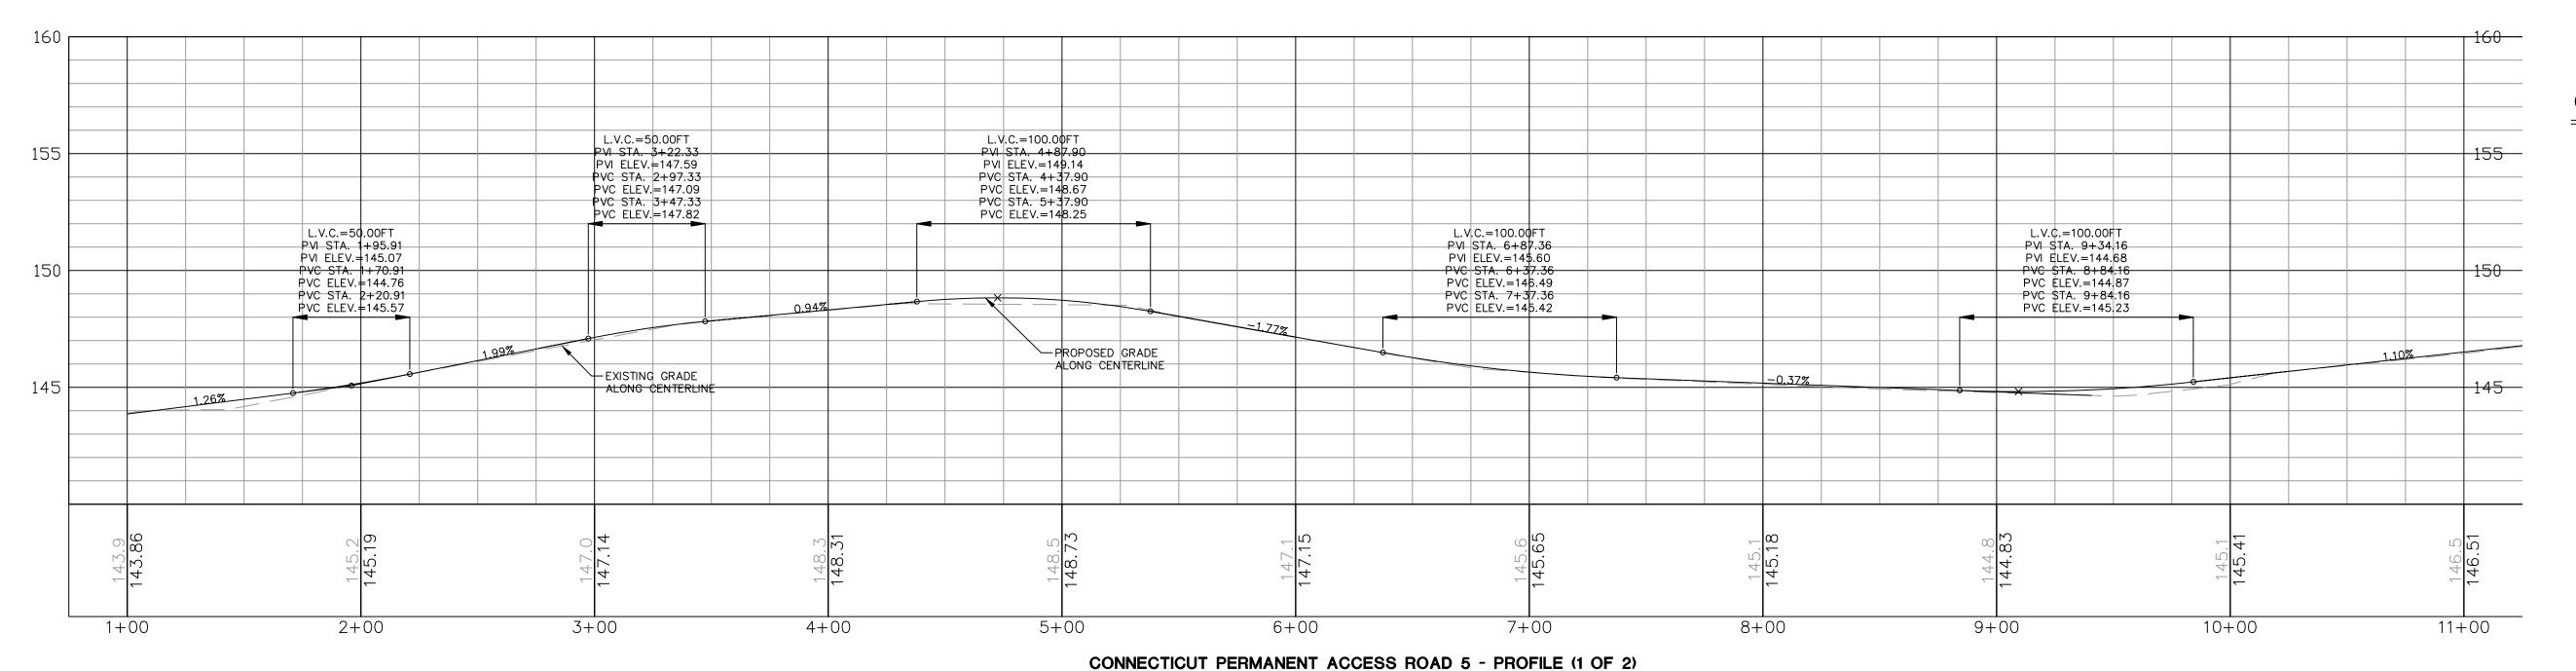

- 1. CHECK DAMS SHALL BE INSTALLED WITHIN ALL SWALES IN ACCORDANCE WITH THE KINDER MORGAN BMP FIGURE NO. 22. 2. REFER TO KINDER MORGAN CONSTRUCTION BEST MANAGEMENT PRACTICE MANUAL AND SHEETS TITLED "EROSION AND SEDIMENTATION NOTES," "GENERAL SEEDING NOTES," AND
- "RECYCLING AND DISPOSAL PLAN," FOR SPECIFIC INSTALLATION AND MAINTENANCE SPECIFICATIONS, AND EROSION CONTROLS. 3. PROPOSED TRUCK PULL OFF ARE TEMPORARY AND SHALL BE REGRADED TO MATCH PRE CONSTRUCTION CONTOURS WHERE PRACTICAL. ALL PROPOSED PERMANENT SWALES AND ASSOCIATED
- CHECK DAMS SHALL BE REMOVED AND REINSTALLED ALONG THE PROPOSED EDGE OF ROAD. 4. THE CONTRACTOR SHALL VERIFY ALL EXISTING CONDITIONS PRIOR TO CONSTRUCTION. THE CONTRACTOR SHALL IMMEDIATELY NOTIFY KINDER MORGAN. INC. AND/OR ITS ENGINEER OF ANY CONDITIONS
- THAT VARY FROM WHAT IS DEPICTED ON THIS PLAN. 5. THE CONTRACTOR SHALL CONTACT CALL BEFORE YOU DIG CONNECTICUT (1-800-922-4455) A MINIMUM OF 72 HOURS PRIOR
- TO COMMENCEMENT OF CONSTRUCTION. 6. ALL SLOPES THAT ARE EQUAL TO OR STEEPER THAN 1(V): 3(H) SHALL BE SEEDED AND THEN COVERED WITH EROSION CONTROL MATTING PER KINDER MORGAN BMP NO. 41. THE MATTING SHALL BE
- ACCORDANCE WITH THE MANUFACTURERS SPECIFICATIONS. SEE DETAIL IN THE CONSTRUCTION BEST MANAGEMENT PRACTICES. 7. ALL SLOPES THAT ARE STEEPER THAN 1(V): 2(H) SHALL BE COVERED WITH RIPRAP SLOPE PROTECTION. SEE SLOPE PROTECTION DETAIL FOR INSTALLATION GUIDELINES IN THE CONSTRUCTION BEST

INTERLOCKING TIMBER MATS OR APPROVED EQUAL AND INSTALLED IN

MANAGEMENT PRACTICES. 8. CONSTRUCTION ENTRANCES ARE TO BE CONSTRUCTED ON TEMPORARY ACCESS ROADS IF EXCESSIVE SEDIMENT IS CONVEYED ONTO THE MAIN TRAVEL WAY.

LEGEND

PROPOSED PIPELINE EXISTING PIPELINE PROPERTY LINE STRUCTURE ELEC CABLE FENCE -X-X-X-X-X-X-X-TREE LINE FIBER OPTIC LINE POWER LINES TELEPHONE CABLE TELEPHONE LINE CABLE LINE SILT FENCE PROPOSED EDGE OF ROAD

PROPOSED SILT FENCE

PROPOSED R.O.W. - VARIES SEE PLAN /PROPOSED GRADE EXISTING GRADE EXISTING GRADE IN CUT EXISTING GRADE -

TYPICAL SECTION STA. 1+00 TO 21+91.26

TYPICAL SECTION LEGEND

1) CENTERLINE OF ACCESS ROAD

(2) 12" LAYER CRUSHER RUN STONE, GRADING "A" (M02.06, CONNDOT 816) (3) SEPARATION FILTER FABRIC (TENCATE GEOSYNTHETICS 170N OR APPROVED EQUAL) 4 UNDISTURBED GROUND IN CUTS/SUBBASE IN FILLS

(5) EROSION CONTROL BLANKET, TOPSOIL AND SEED

SCALE IN FEET VERTICAL SCALE 1"=4" GRAPHIC SCALE SCALE IN FEET

GRAPHIC SCALE

DRAWING NUMBER DRAWING TITLE REFERENCE DRAWINGS NO. DATE BY REVISIONS Tennessee Gas Pipeline Company, L.L.C. HORIZONTAL SCALE 1"=40' a Kinder Morgan company


CONNECTICUT EXPANSION PROJECT CONNECTICUT LOOP 300-500 PROPOSED NATURAL GAS PIPELINE TOWN OF SUFFIELD


HARTFORD COUNTY, CONNECTICUT Co./Par.: HARTFORD Township: SUFFIELD Range: Drafter: JMS | Date: 07/08/14 | Project ID: Chk'd: AP Date: 4/21/15

Appr: DK Date: 4/21/15

Sheet: Rev.

PROJ. ID APPR

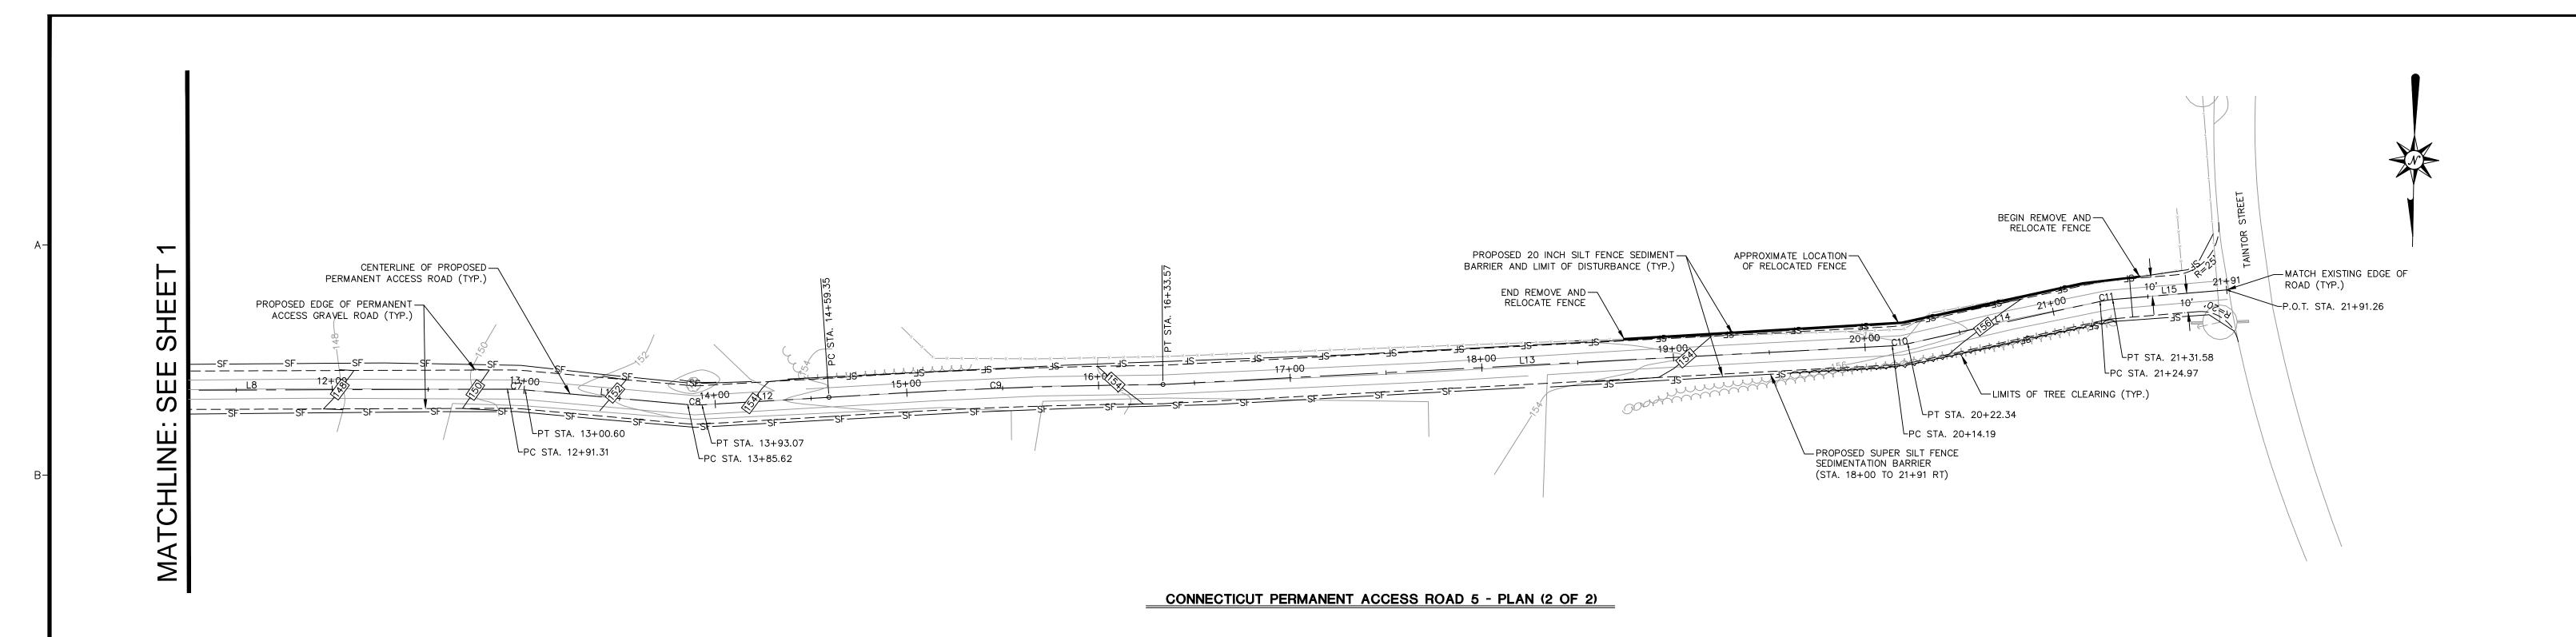

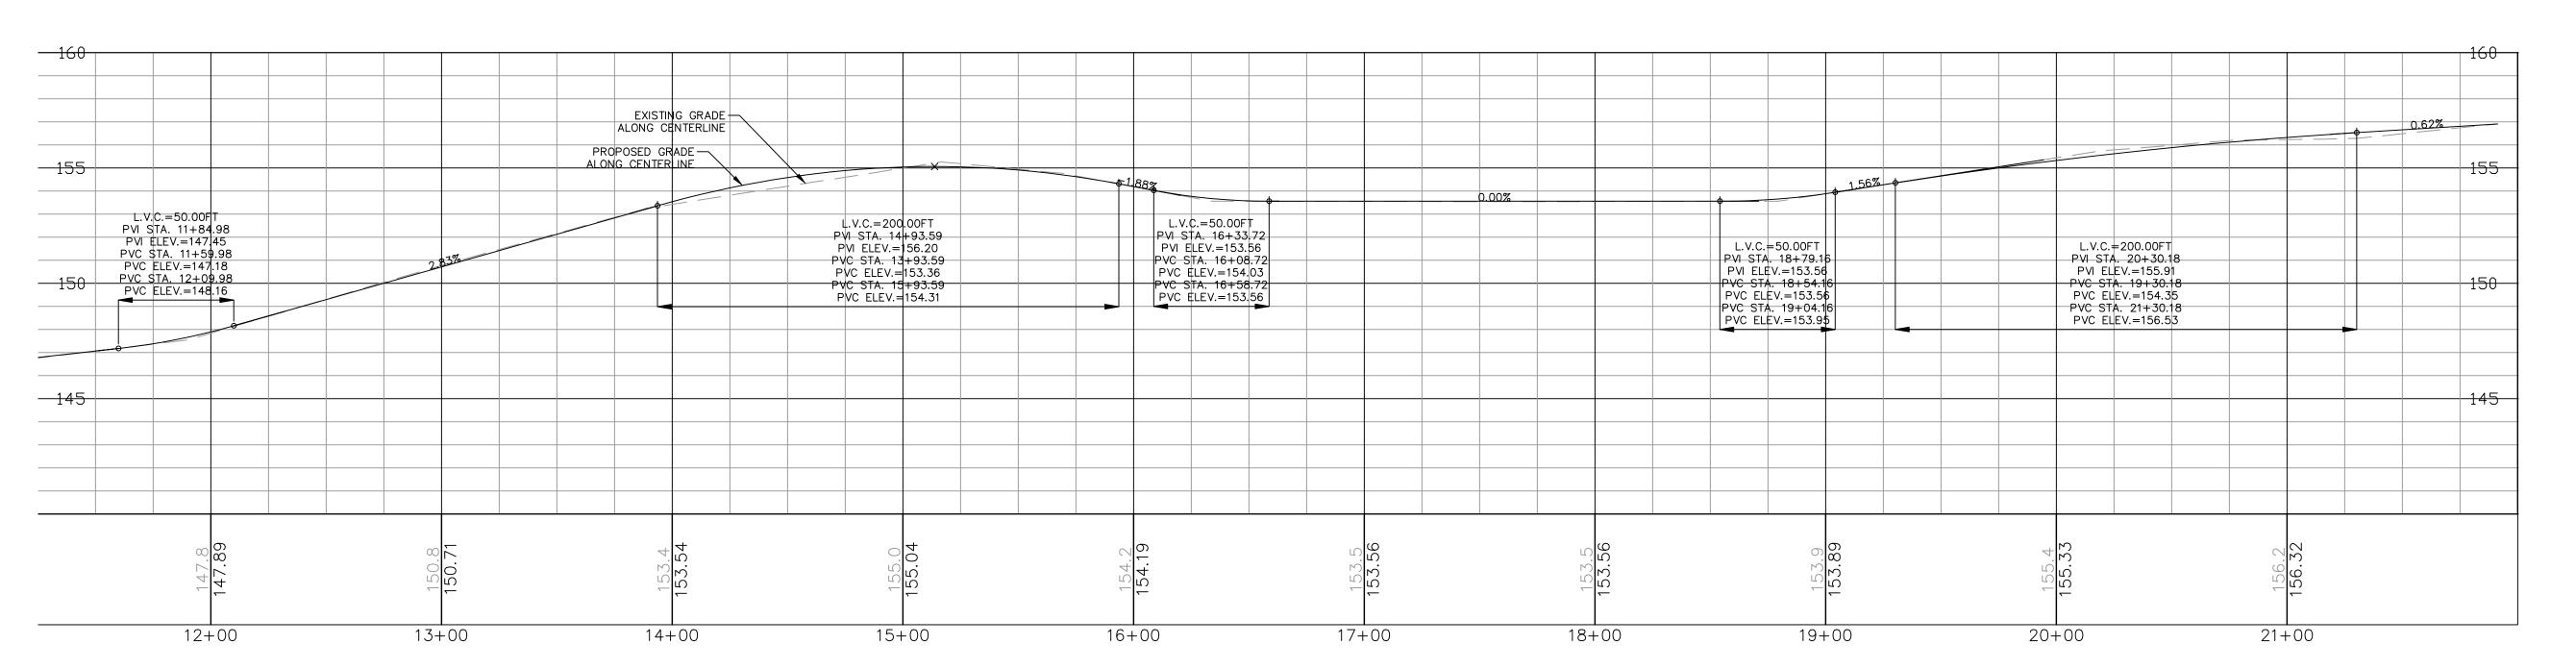

CONNECTICUT	PERMANENT	ACCESS	ROAD 5	- PROFILE	(2	OF	2)

PAR CT-5							
No.	Northing	Easting	Bearing	Delta(∆)	Length	Tangent	Radius
L8	B 15256205.57 E 15256200.01	B 2272215.52 E 2271949.08	S88°48'12.57"W		266.50		
C7	PC 15256200.01 PI 15256199.91 PT 15256200.25	PC 2271949.08 PI 2271944.43 PT 2271939.79		5 ° 19'24"	9.29'	4.65'	100.0'
L11	B 15256200.25 E 15256206.43	B 2271939.79 E 2271855.00	N85°50'01.41"W		85.02		
C8	PC 15256206.43 PI 15256206.70 PT 15256206.42	PC 2271855.00 PI 2271851.28 PT 2271847.56		8 ° 31'55"	7.45'	3.73'	50.0'
L12	B 15256206.42 E 15256201.37	B 2271847.56 E 2271781.47	S85°38'03.72"W		66.29'		
С9	PC 15256201.37 PI 15256193.91 PT 15256191.64	PC 2271781.47 PI 2271694.65 PT 2271607.55		3°24'59"	174.21	87.13'	2921.6'
L13	B 15256191.64 E 15256164.85	B 2271607.55 E 2271227.87	S85°57'47.79"W		380.62		
C10	PC 15256164.85 PI 15256164.56 PT 15256163.61	PC 2271227.87 PI 2271223.80 PT 2271219.83		9*20'10"	8.15'	4.08'	50.0'
L14	B 15256163.61 E 15256139.82	B 2271219.83 E 2271119.99	S76°35'56.85"W		102.63'		
C11	PC 15256139.82 PI 15256139.06 PT 15256138.72	PC 2271119.99 PI 2271116.77 PT 2271113.48		7 ° 34'19"	6.61'	3.31'	50.0'
L15	B 15256138.72 E 15256132.66	B 2271113.48 E 2271054.11	S84°10'16.28"W		59.68		

- 1. CHECK DAMS SHALL BE INSTALLED WITHIN ALL SWALES IN
- ACCORDANCE WITH THE KINDER MORGAN BMP FIGURE NO. 22.


 2. REFER TO KINDER MORGAN CONSTRUCTION BEST MANAGEMENT PRACTICE MANUAL AND SHEETS TITLED "EROSION AND SEDIMENTATION NOTES," "GENERAL SEEDING NOTES," AND
- MAINTENANCE SPECIFICATIONS, AND EROSION CONTROLS.

 3. PROPOSED TRUCK PULL OFF ARE TEMPORARY AND SHALL BE REMOVED AFTER CONSTRUCTION. THE PULL OFF AREA SHALL BE REGRADED TO MATCH PRE CONSTRUCTION CONTOURS WHERE PRACTICAL. ALL PROPOSED PERMANENT SWALES AND ASSOCIATED CHECK DAMS SHALL BE REMOVED AND REINSTALLED ALONG THE

"RECYCLING AND DISPOSAL PLAN," FOR SPECIFIC INSTALLATION AND

- PROPOSED EDGE OF ROAD. 4. THE CONTRACTOR SHALL VERIFY ALL EXISTING CONDITIONS PRIOR TO CONSTRUCTION. THE CONTRACTOR SHALL IMMEDIATELY NOTIFY KINDER MORGAN. INC. AND/OR ITS ENGINEER OF ANY CONDITIONS THAT VARY FROM WHAT IS DEPICTED ON THIS PLAN.
- 5. THE CONTRACTOR SHALL CONTACT CALL BEFORE YOU DIG CONNECTICUT (1-800-922-4455) A MINIMUM OF 72 HOURS PRIOR TO COMMENCEMENT OF CONSTRUCTION. 6. ALL SLOPES THAT ARE EQUAL TO OR STEEPER THAN 1(V): 3(H) SHALL BE SEEDED AND THEN COVERED WITH EROSION CONTROL
- MATTING PER KINDER MORGAN BMP NO. 41. THE MATTING SHALL BE INTERLOCKING TIMBER MATS OR APPROVED EQUAL AND INSTALLED IN ACCORDANCE WITH THE MANUFACTURERS SPECIFICATIONS. SEE DETAIL IN THE CONSTRUCTION BEST MANAGEMENT PRACTICES. 7. ALL SLOPES THAT ARE STEEPER THAN 1(V): 2(H) SHALL BE COVERED WITH RIPRAP SLOPE PROTECTION. SEE SLOPE PROTECTION DETAIL
- MANAGEMENT PRACTICES. 8. CONSTRUCTION ENTRANCES ARE TO BE CONSTRUCTED ON TEMPORARY ACCESS ROADS IF EXCESSIVE SEDIMENT IS CONVEYED ONTO THE MAIN TRAVEL WAY.

FOR INSTALLATION GUIDELINES IN THE CONSTRUCTION BEST

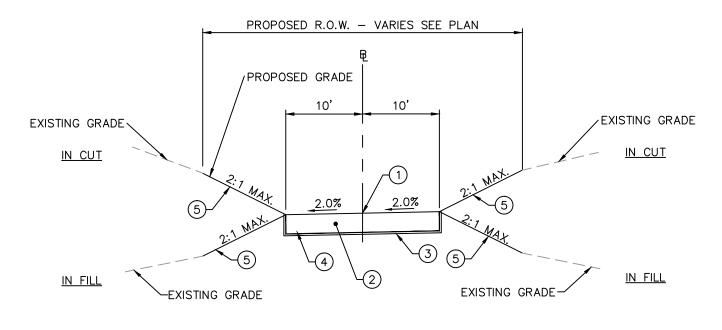


TYPICAL SECTION STA. 1+00 TO 21+91.26

TYPICAL SECTION LEGEND

(1) CENTERLINE OF ACCESS ROAD

- 2)12" LAYER CRUSHER RUN STONE, GRADING "A" (M02.06, CONNDOT 816)
- (3) SEPARATION FILTER FABRIC (TENCATE GEOSYNTHETICS 170N OR APPROVED EQUAL)
- 4 UNDISTURBED GROUND IN CUTS/SUBBASE IN FILLS
- (5) EROSION CONTROL BLANKET, TOPSOIL AND SEED

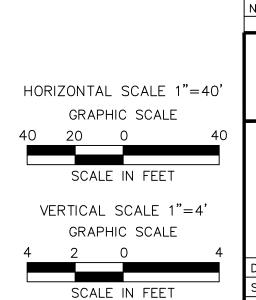

DRAWING TITLE DRAWING NUMBER REFERENCE DRAWINGS DESCRIPTION PROJ. ID APPR. NO. DATE BY REVISIONS

Tennessee Gas Pipeline Company, L.L.C. a Kinder Morgan company

LEGEND

PROPOSED PIPELINE

EXISTING PIPELINE

STRUCTURE

ELEC CABLE

TREE LINE

FIBER OPTIC LINE

TELEPHONE CABLE

TELEPHONE LINE

PROPOSED EDGE OF ROAD

PROPOSED SILT FENCE

CABLE LINE

SILT FENCE

POWER LINES


_x-_x-_x-_x-_x-

FENCE

CONNECTICUT EXPANSION PROJECT CONNECTICUT LOOP 300-500 PROPOSED NATURAL GAS PIPELINE TOWN OF SUFFIELD

HARTFORD COUNTY, CONNECTICUT Op. Area: Co./Par.: HARTFORD Township: SUFFIELD Range: Drafter: JMS | Date: 07/08/14 | Project ID: Chk'd: AP Date: 4/21/15

Appr: DK Date: 4/21/15 Sheet: Rev.

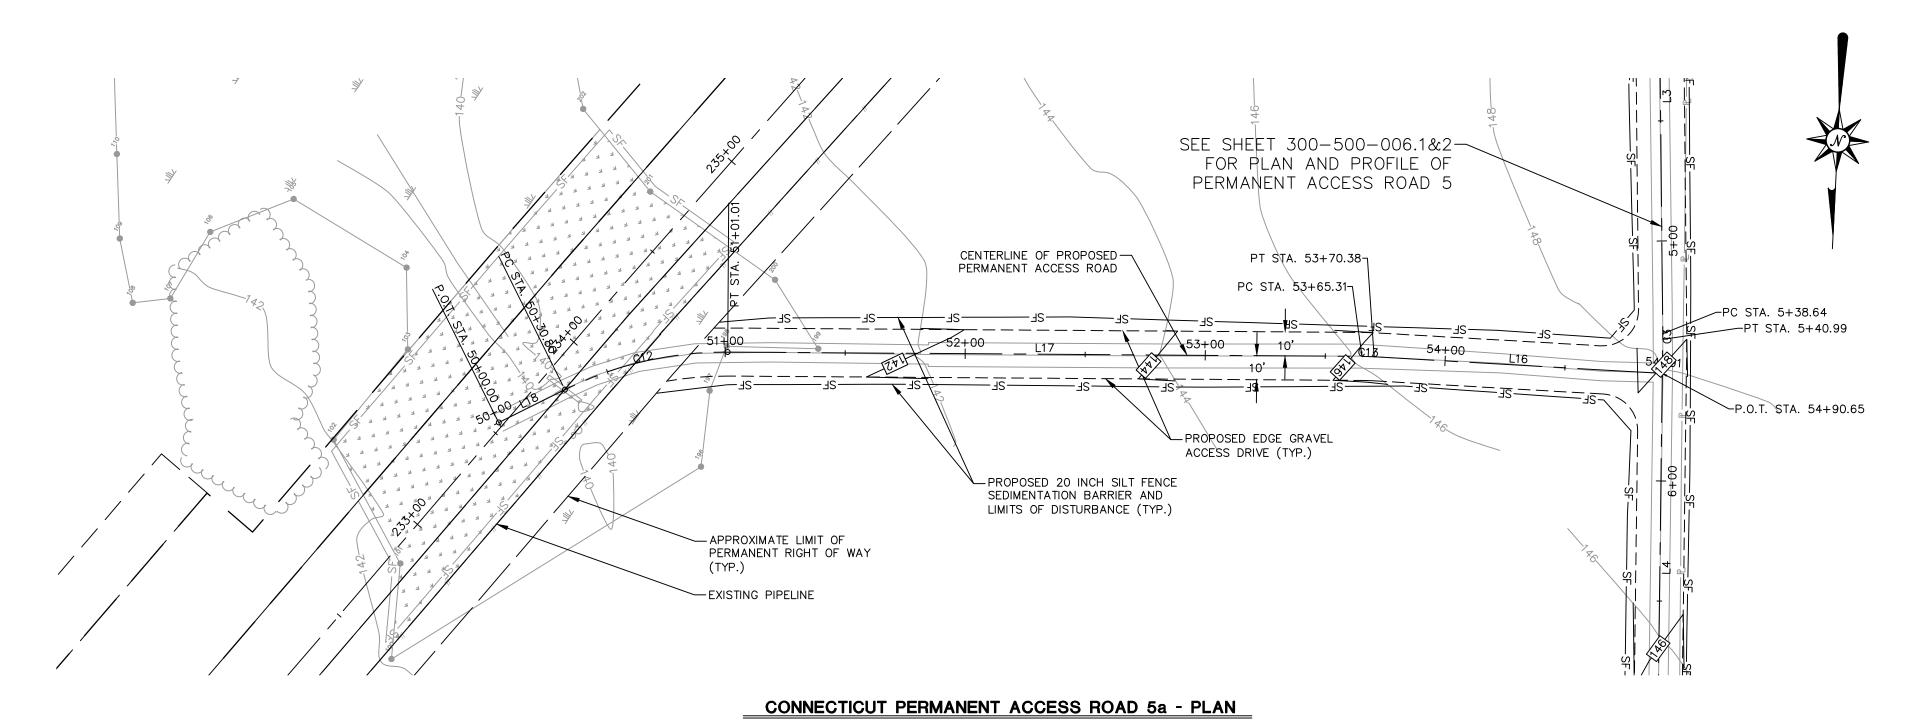

			PAR CT-5a				
No.	Northing	Easting	Bearing	Delta(△)	Length	Tangent	Radius
L18	B 15255820.13 E 15255804.53	B 2272755.54 E 2272728.98	S59*34'34.38"W		30.80'		
C12	PC 15255804.53 PI 15255786.42 PT 15255784.18	PC 2272728.98 PI 2272698.14 PT 2272662.45		26°49'06"	70.21'	35.76'	150.0'
L17	B 15255784.18 E 15255767.55	B 2272662.45 E 2272398.67	S86°23'40.14"W		264.30'		
C13	PC 15255767.55 PI 15255767.39 PT 15255767.36	PC 2272398.67 PI 2272396.14 PT 2272393.61		2*54'13"	5.07'	2.53'	100.0'
L16	B 15255767.36 E 15255765.89	B 2272393.61 E 2272273.35	S89°17'52.87"W		120.27		

- 1. CHECK DAMS SHALL BE INSTALLED WITHIN ALL SWALES IN ACCORDANCE WITH THE KINDER MORGAN BMP FIGURE NO. 22.
- 2. REFER TO KINDER MORGAN CONSTRUCTION BEST MANAGEMENT PRACTICE MANUAL AND SHEETS TITLED "EROSION AND SEDIMENTATION NOTES," "GENERAL SEEDING NOTES," AND
- "RECYCLING AND DISPOSAL PLAN," FOR SPECIFIC INSTALLATION AND MAINTENANCE SPECIFICATIONS, AND EROSION CONTROLS.

 3. PROPOSED TRUCK PULL OFF ARE TEMPORARY AND SHALL BE REMOVED AFTER CONSTRUCTION. THE PULL OFF AREA SHALL BE REGRADED TO MATCH PRE CONSTRUCTION CONTOURS WHERE PRACTICAL. ALL PROPOSED PERMANENT SWALES AND ASSOCIATED
- PROPOSED EDGE OF ROAD.


 4. THE CONTRACTOR SHALL VERIFY ALL EXISTING CONDITIONS PRIOR TO CONSTRUCTION. THE CONTRACTOR SHALL IMMEDIATELY NOTIFY KINDER MORGAN. INC. AND/OR ITS ENGINEER OF ANY CONDITIONS THAT VARY FROM WHAT IS DEPICTED ON THIS PLAN.
- 5. THE CONTRACTOR SHALL CONTACT CALL BEFORE YOU DIG CONNECTICUT (1-800-922-4455) A MINIMUM OF 72 HOURS PRIOR TO COMMENCEMENT OF CONSTRUCTION.

CHECK DAMS SHALL BE REMOVED AND REINSTALLED ALONG THE

- 6. ALL SLOPES THAT ARE EQUAL TO OR STEEPER THAN 1(V): 3(H)
 SHALL BE SEEDED AND THEN COVERED WITH EROSION CONTROL
 MATTING PER KINDER MORGAN BMP NO. 41. THE MATTING SHALL BE
 INTERLOCKING TIMBER MATS OR APPROVED EQUAL AND INSTALLED IN
 ACCORDANCE WITH THE MANUFACTURERS SPECIFICATIONS. SEE
 DETAIL IN THE CONSTRUCTION BEST MANAGEMENT PRACTICES.
- 7. ALL SLOPES THAT ARE STEEPER THAN 1(V): 2(H) SHALL BE COVERED WITH RIPRAP SLOPE PROTECTION. SEE SLOPE PROTECTION DETAIL FOR INSTALLATION GUIDELINES IN THE CONSTRUCTION BEST MANAGEMENT PRACTICES.
- 8. CONSTRUCTION ENTRANCES ARE TO BE CONSTRUCTED ON TEMPORARY ACCESS ROADS IF EXCESSIVE SEDIMENT IS CONVEYED ONTO THE MAIN TRAVEL WAY.

TYPICAL SECTION LEGEND


- (1) CENTERLINE OF ACCESS ROAD
- (2) 12" LAYER CRUSHER RUN STONE, GRADING "A" (M02.06, CONNDOT 816)
- (3) SEPARATION FILTER FABRIC (TENCATE GEOSYNTHETICS 170N OR APPROVED EQUAL)
- 4 UNDISTURBED GROUND IN CUTS/SUBBASE IN FILLS
- (5) EROSION CONTROL BLANKET, TOPSOIL AND SEED

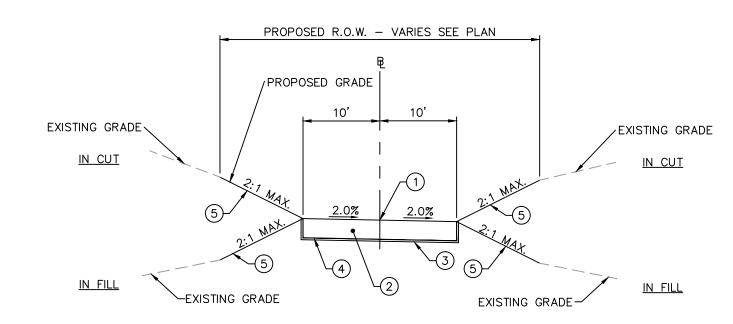



TYPICAL SECTION STA. 1+00 TO 7+67.15


.V.C.=75.00FT PVI STA. 54+18.39 PVI ELEV.=147.41 PVC STA. 53+80.89 PVC ELEV.=146.48 PVC STA. 54+55.89 PVC ELEV.=147.68 L.V.C.=50.00FT ALONG CENTERLINE PVI \$TA. 52+11.25 PVI ELEV.=142.30 PVC \$TA. 51+86.25 PVC ELEV.=142.06 PVC \$TA. 52+36.25 145 PVC ELEV.=142.91 EXISTING GRADE ALONG CENTERLINE 140 50+00 51 + 0052+00 53+00 54+00 55+00

LEGEND CONNECTICUT PERMANENT ACCESS ROAD 5a - PROFILE

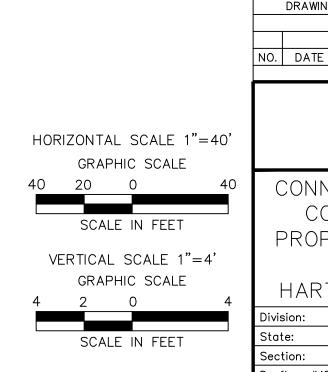

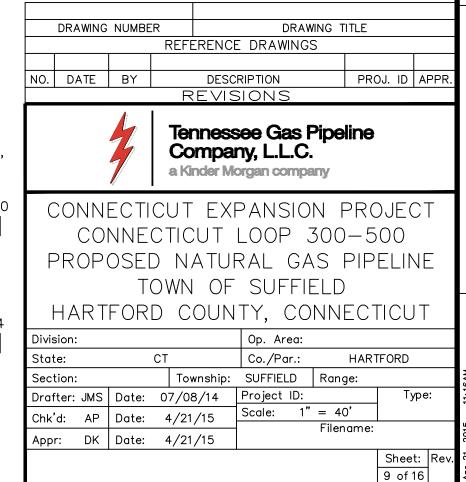

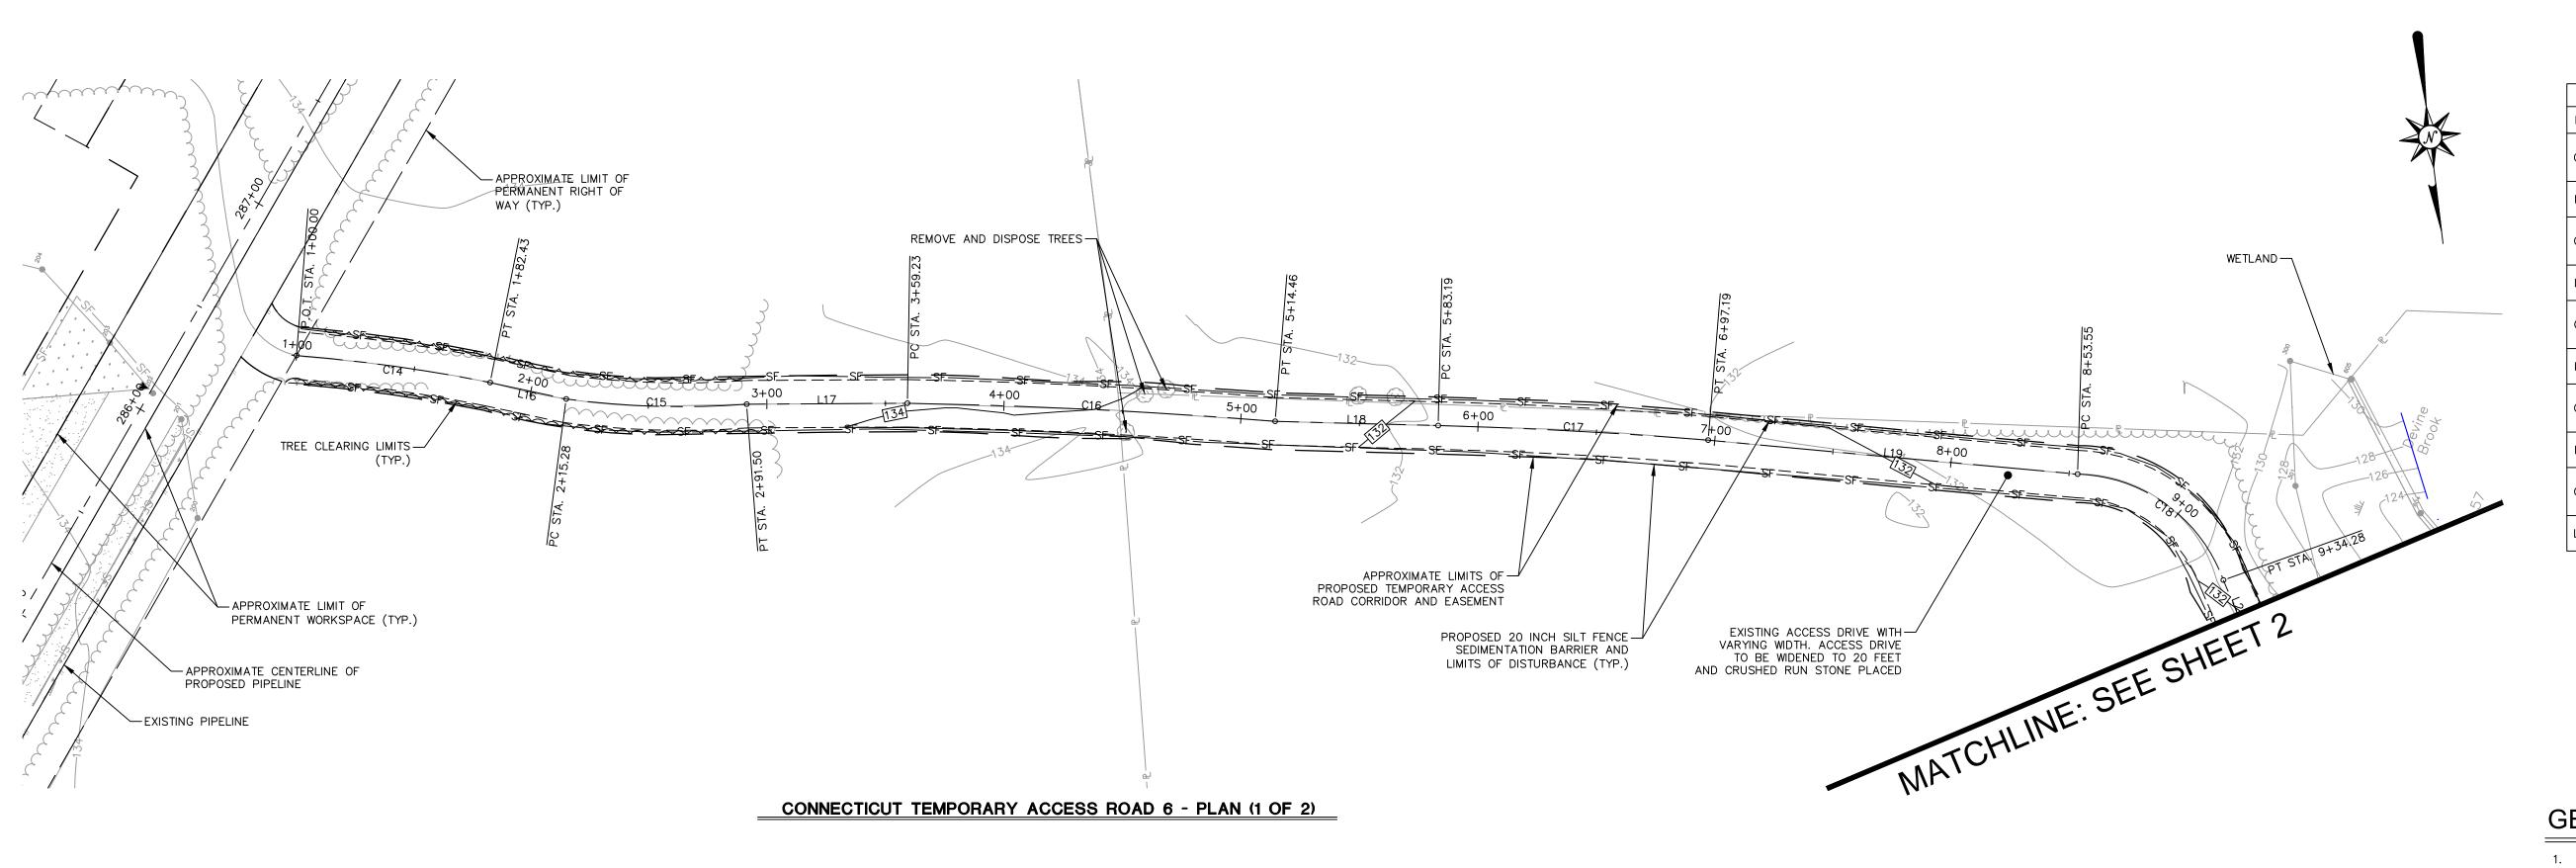


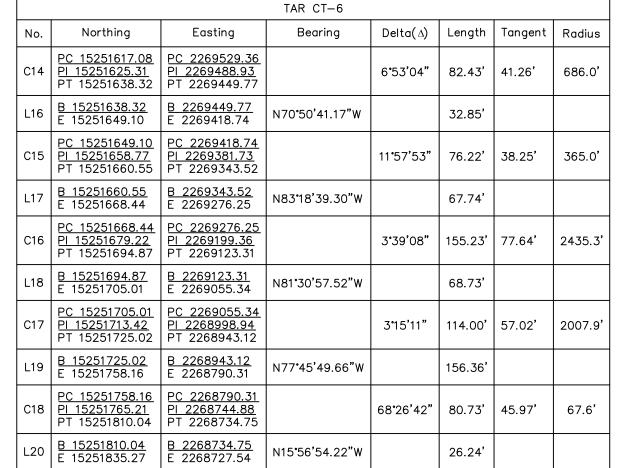

- 1. CHECK DAMS SHALL BE INSTALLED WITHIN ALL SWALES IN ACCORDANCE WITH THE KINDER MORGAN BMP FIGURE NO. 22. 2. REFER TO KINDER MORGAN CONSTRUCTION BEST MANAGEMENT PRACTICE MANUAL AND SHEETS TITLED "EROSION AND SEDIMENTATION NOTES," "GENERAL SEEDING NOTES," AND
- "RECYCLING AND DISPOSAL PLAN," FOR SPECIFIC INSTALLATION AND MAINTENANCE SPECIFICATIONS, AND EROSION CONTROLS. 3. PROPOSED TRUCK PULL OFF ARE TEMPORARY AND SHALL BE REMOVED AFTER CONSTRUCTION. THE PULL OFF AREA SHALL BE REGRADED TO MATCH PRE CONSTRUCTION CONTOURS WHERE PRACTICAL. ALL PROPOSED PERMANENT SWALES AND ASSOCIATED CHECK DAMS SHALL BE REMOVED AND REINSTALLED ALONG THE
- PROPOSED EDGE OF ROAD. 4. THE CONTRACTOR SHALL VERIFY ALL EXISTING CONDITIONS PRIOR TO CONSTRUCTION. THE CONTRACTOR SHALL IMMEDIATELY NOTIFY KINDER MORGAN. INC. AND/OR ITS ENGINEER OF ANY CONDITIONS THAT VARY FROM WHAT IS DEPICTED ON THIS PLAN.
- 5. THE CONTRACTOR SHALL CONTACT CALL BEFORE YOU DIG CONNECTICUT (1-800-922-4455) A MINIMUM OF 72 HOURS PRIOR TO COMMENCEMENT OF CONSTRUCTION. 6. ALL SLOPES THAT ARE EQUAL TO OR STEEPER THAN 1(V): 3(H)
- SHALL BE SEEDED AND THEN COVERED WITH EROSION CONTROL MATTING PER KINDER MORGAN BMP NO. 41. THE MATTING SHALL BE INTERLOCKING TIMBER MATS OR APPROVED EQUAL AND INSTALLED IN ACCORDANCE WITH THE MANUFACTURERS SPECIFICATIONS. SEE DETAIL IN THE CONSTRUCTION BEST MANAGEMENT PRACTICES. 7. ALL SLOPES THAT ARE STEEPER THAN 1(V): 2(H) SHALL BE COVERED

WITH RIPRAP SLOPE PROTECTION. SEE SLOPE PROTECTION DETAIL

FOR INSTALLATION GUIDELINES IN THE CONSTRUCTION BEST MANAGEMENT PRACTICES. 8. CONSTRUCTION ENTRANCES ARE TO BE CONSTRUCTED ON TEMPORARY ACCESS ROADS IF EXCESSIVE SEDIMENT IS CONVEYED ONTO THE MAIN TRAVEL WAY.

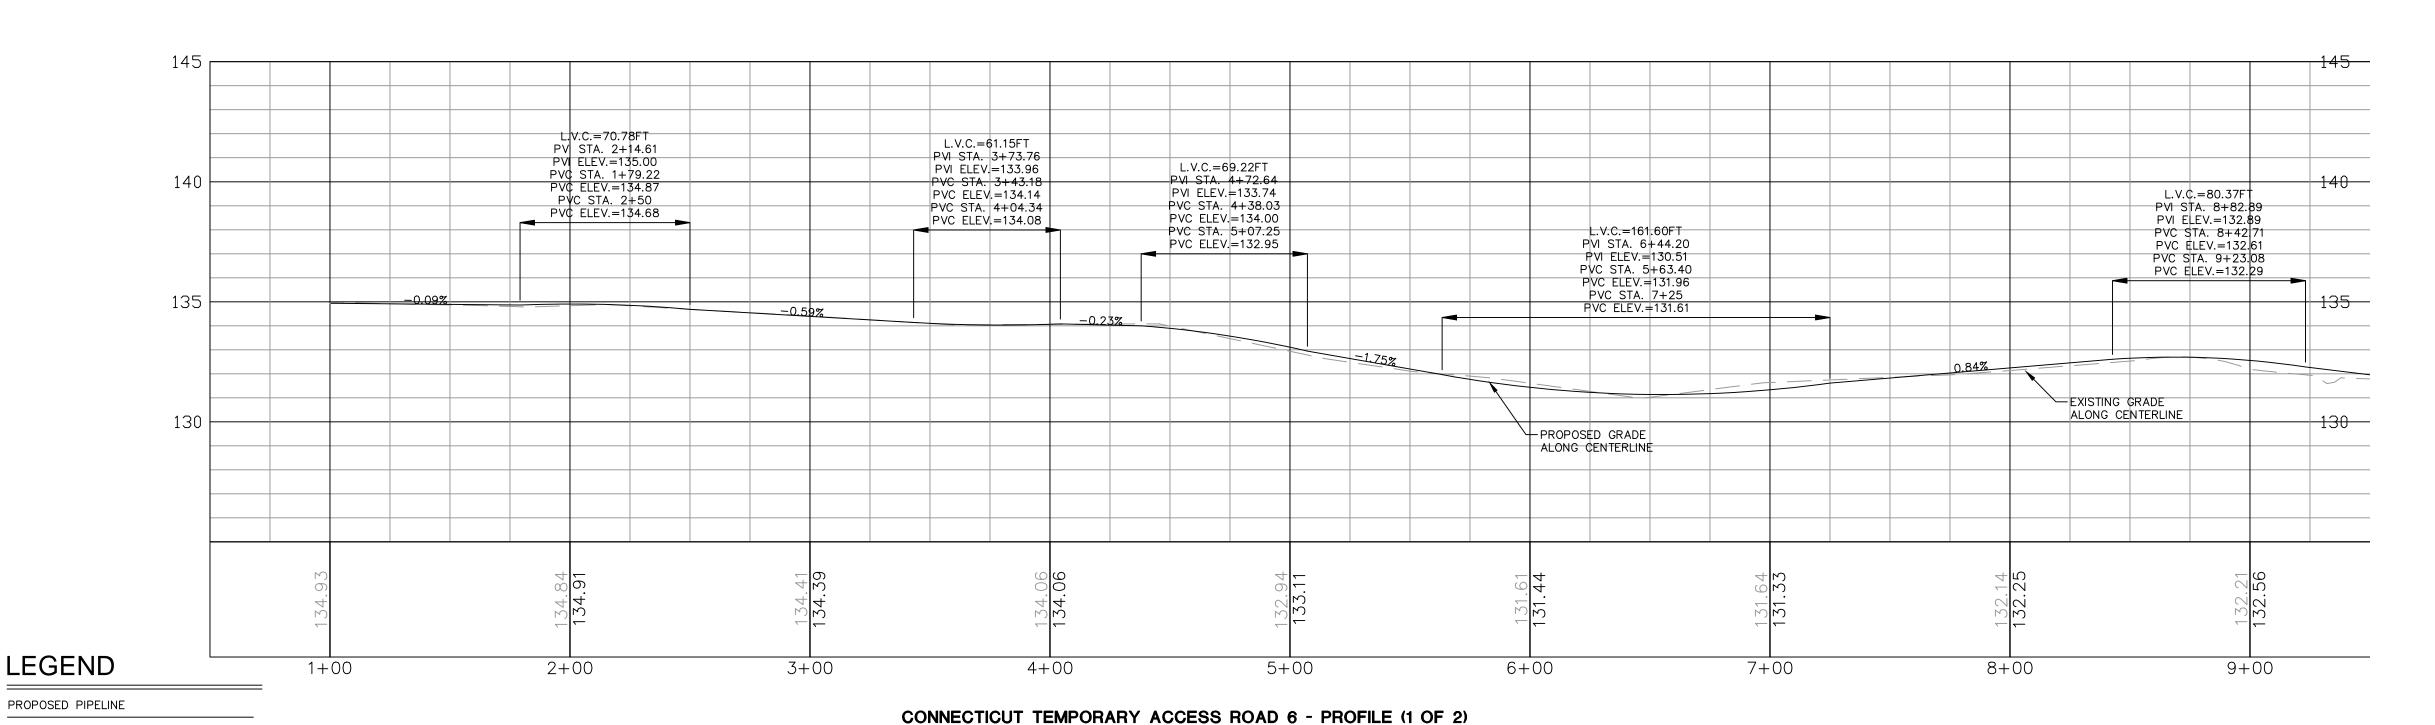

EXISTING PIPELINE PROPERTY LINE PROPOSED R.O.W. - VARIES SEE PLAN STRUCTURE ELEC CABLE /PROPOSED GRADE FENCE EXISTING GRADE TREE LINE IN CUT FIBER OPTIC LINE POWER LINES TELEPHONE CABLE <u>IN FILL</u> TELEPHONE LINE

CABLE LINE

SILT FENCE

PROPOSED EDGE OF ROAD

PROPOSED SILT FENCE

TYPICAL SECTION LEGEND

(1) CENTERLINE OF ACCESS ROAD

EXISTING GRADE


IN CUT


(2)12" LAYER CRUSHER RUN STONE, GRADING "A" (MO2.06, CONNDOT 816)

(3) SEPARATION FILTER FABRIC (TENCATE GEOSYNTHETICS 170N OR APPROVED EQUAL)

(4) UNDISTURBED GROUND IN CUTS/SUBBASE IN FILLS

(5) EROSION CONTROL BLANKET, TOPSOIL AND SEED

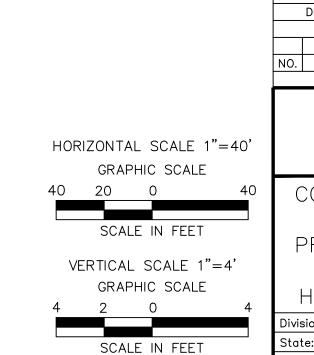

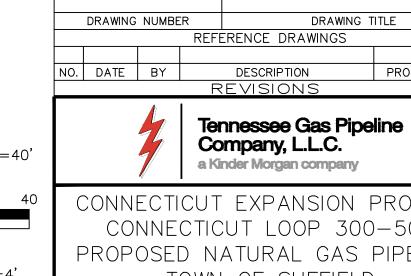

CONNECTICUT EXPANSION PROJECT CONNECTICUT LOOP 300-500 PROPOSED NATURAL GAS PIPELINE TOWN OF SUFFIELD


PROJ. ID APPR


HARTFORD COUNTY, CONNECTICUT Co./Par.: HARTFORD Township: SUFFIELD Range: Drafter: JMS | Date: 07/08/14 | Project ID: Chk'd: AP Date: 4/21/15

Appr: DK Date: 4/21/15 Sheet: Rev.

TYPICAL SECTION STA. 1+00 TO 14+13.86

EXISTING GRADE -

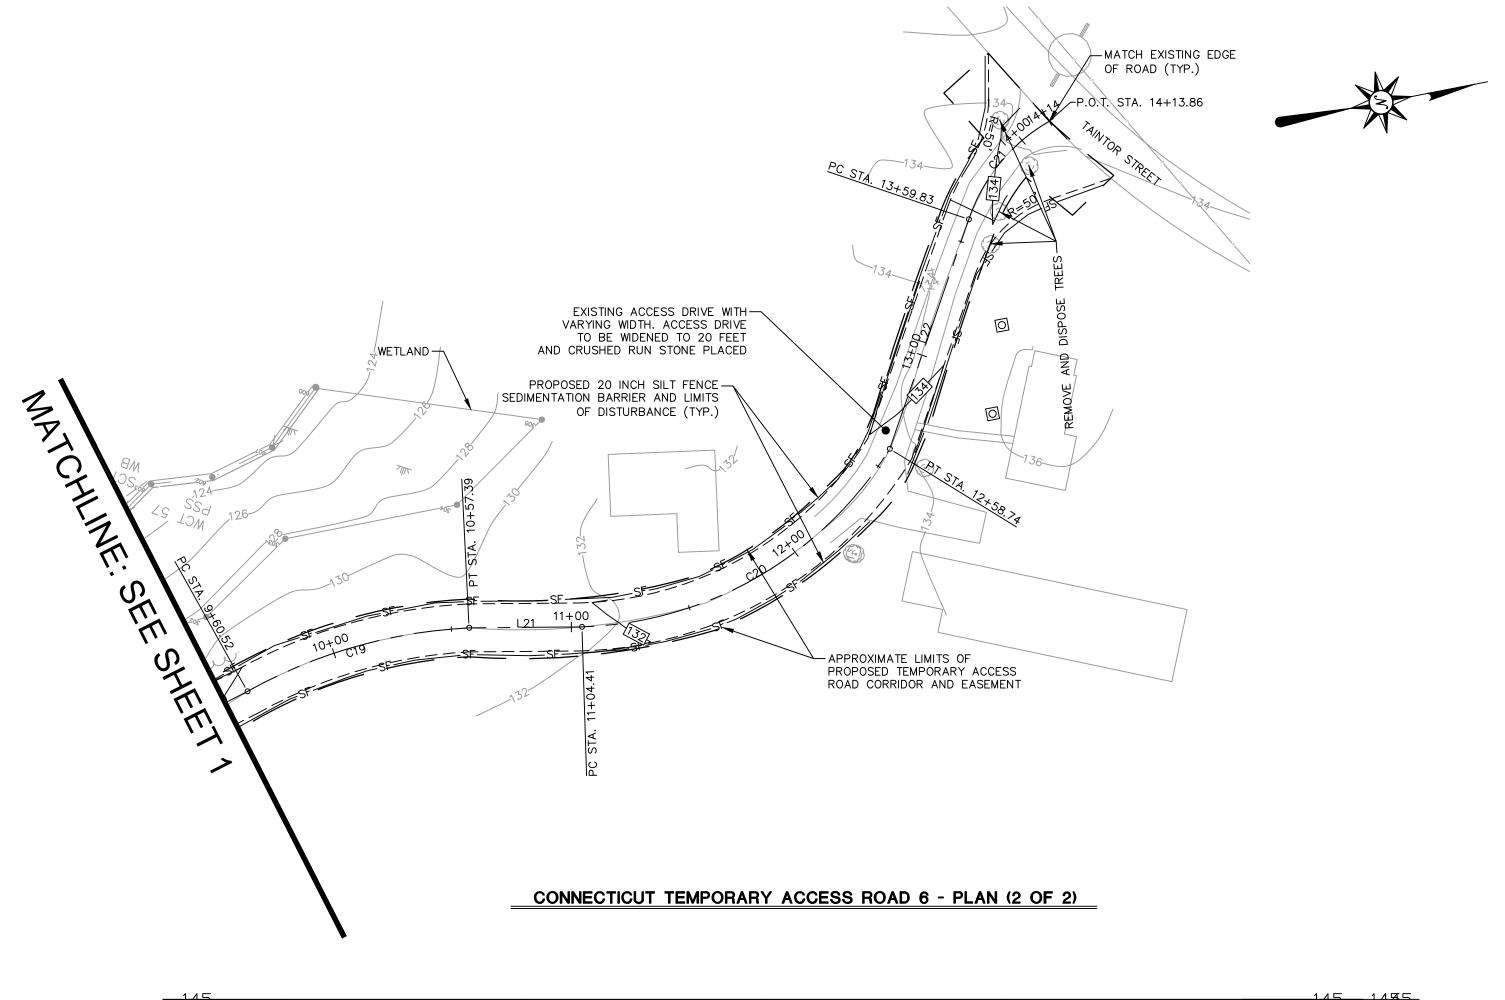

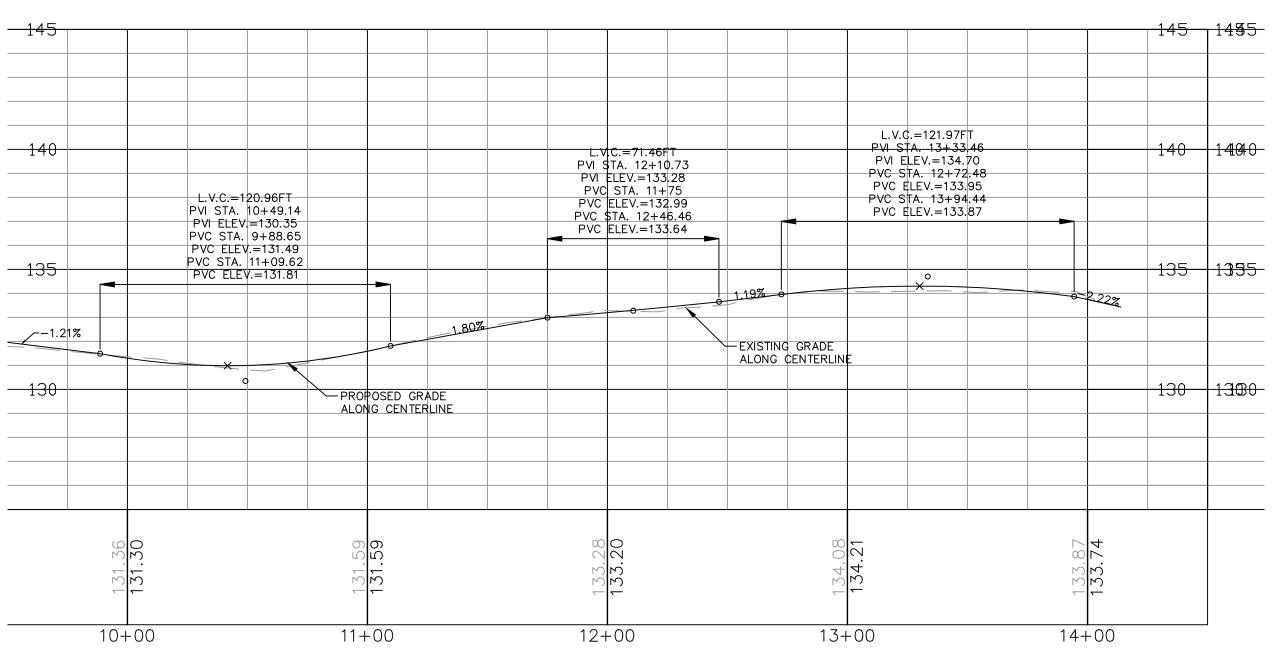


LEGEND

PROPOSED PIPELINE EXISTING PIPELINE PROPERTY LINE STRUCTURE FENCE _X---X---X---X---X---TREE LINE FIBER OPTIC LINE POWER LINES TELEPHONE CABLE TELEPHONE LINE CABLE LINE SILT FENCE PROPOSED EDGE OF ROAD ______

PROPOSED SILT FENCE

CONNECTICUT TEMPORARY ACCESS ROAD 6 - PROFILE (2 OF 2)

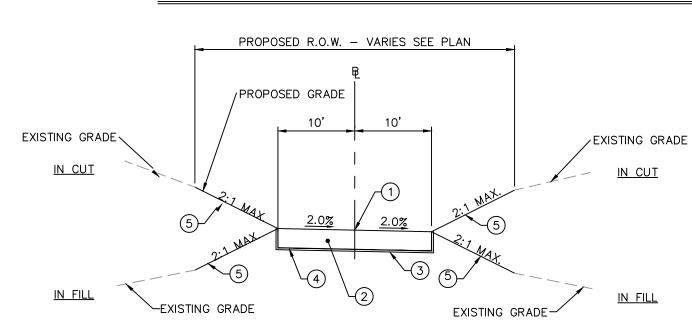

TYPICAL SECTION STA. 1+00 TO 14+13.86

TYPICAL SECTION LEGEND

- (1) CENTERLINE OF ACCESS ROAD
- (2)12" LAYER CRUSHER RUN STONE, GRADING "A" (M02.06, CONNDOT 816)
- 3 SEPARATION FILTER FABRIC (TENCATE GEOSYNTHETICS 170N OR APPROVED EQUAL)
- 4 UNDISTURBED GROUND IN CUTS/SUBBASE IN FILLS
- (5) EROSION CONTROL BLANKET, TOPSOIL AND SEED

TAR CT-6 Northing Easting Bearing Delta(Δ) | Length | Tangent | Radius 26°23'40" | 96.87' | 49.31' | 210.3' T 15251930.92 B 2268719.17 E 2268727.76 47.01 N10°31'41.94"E C 2268727.76 PI 2268741.21 PT 2268679.36 56°32'34" | 154.33' | 84.11' T 15252117.16 B 15252117.16 E 15252167.71 B 2268679.36 E 2268591.82 101.09' N59**°**59'47.04"W PC 15252167.71 PI 15252181.71 PT 15252208.44 PT 2268557.29 PT 2268558.13 PC 15252167.71 41°22'13" | 54.03' | 28.25' |

GENERAL NOTES


MANAGEMENT PRACTICES.

- 1. CHECK DAMS SHALL BE INSTALLED WITHIN ALL SWALES IN ACCORDANCE WITH THE KINDER MORGAN BMP FIGURE NO. 22. 2. REFER TO KINDER MORGAN CONSTRUCTION BEST MANAGEMENT
- PRACTICE MANUAL AND SHEETS TITLED "EROSION AND SEDIMENTATION NOTES," "GENERAL SEEDING NOTES," AND "RECYCLING AND DISPOSAL PLAN," FOR SPECIFIC INSTALLATION AND
- MAINTENANCE SPECIFICATIONS, AND EROSION CONTROLS.

 3. PROPOSED TRUCK PULL OFF ARE TEMPORARY AND SHALL BE REMOVED AFTER CONSTRUCTION. THE PULL OFF AREA SHALL BE REGRADED TO MATCH PRE CONSTRUCTION CONTOURS WHERE PRACTICAL. ALL PROPOSED PERMANENT SWALES AND ASSOCIATED CHECK DAMS SHALL BE REMOVED AND REINSTALLED ALONG THE PROPOSED EDGE OF ROAD.
- 4. THE CONTRACTOR SHALL VERIFY ALL EXISTING CONDITIONS PRIOR TO CONSTRUCTION. THE CONTRACTOR SHALL IMMEDIATELY NOTIFY KINDER MORGAN. INC. AND/OR ITS ENGINEER OF ANY CONDITIONS THAT VARY FROM WHAT IS DEPICTED ON THIS PLAN. 5. THE CONTRACTOR SHALL CONTACT CALL BEFORE YOU DIG
- CONNECTICUT (1-800-922-4455) A MINIMUM OF 72 HOURS PRIOR TO COMMENCEMENT OF CONSTRUCTION. 6. ALL SLOPES THAT ARE EQUAL TO OR STEEPER THAN 1(V): 3(H) SHALL BE SEEDED AND THEN COVERED WITH EROSION CONTROL MATTING PER KINDER MORGAN BMP NO. 41. THE MATTING SHALL BE


WITH RIPRAP SLOPE PROTECTION. SEE SLOPE PROTECTION DETAIL FOR INSTALLATION GUIDELINES IN THE CONSTRUCTION BEST

- INTERLOCKING TIMBER MATS OR APPROVED EQUAL AND INSTALLED IN ACCORDANCE WITH THE MANUFACTURERS SPECIFICATIONS. SEE DETAIL IN THE CONSTRUCTION BEST MANAGEMENT PRACTICES. 7. ALL SLOPES THAT ARE STEEPER THAN 1(V): 2(H) SHALL BE COVERED
- 8. CONSTRUCTION ENTRANCES ARE TO BE CONSTRUCTED ON TEMPORARY ACCESS ROADS IF EXCESSIVE SEDIMENT IS CONVEYED ONTO THE MAIN TRAVEL WAY.

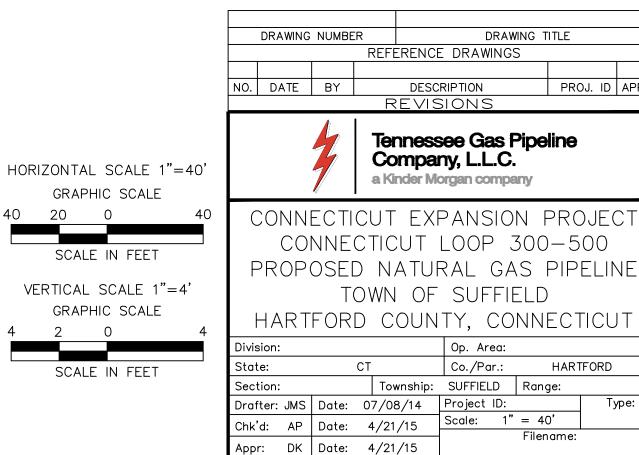


PROJ. ID APPR

Sheet: Rev.

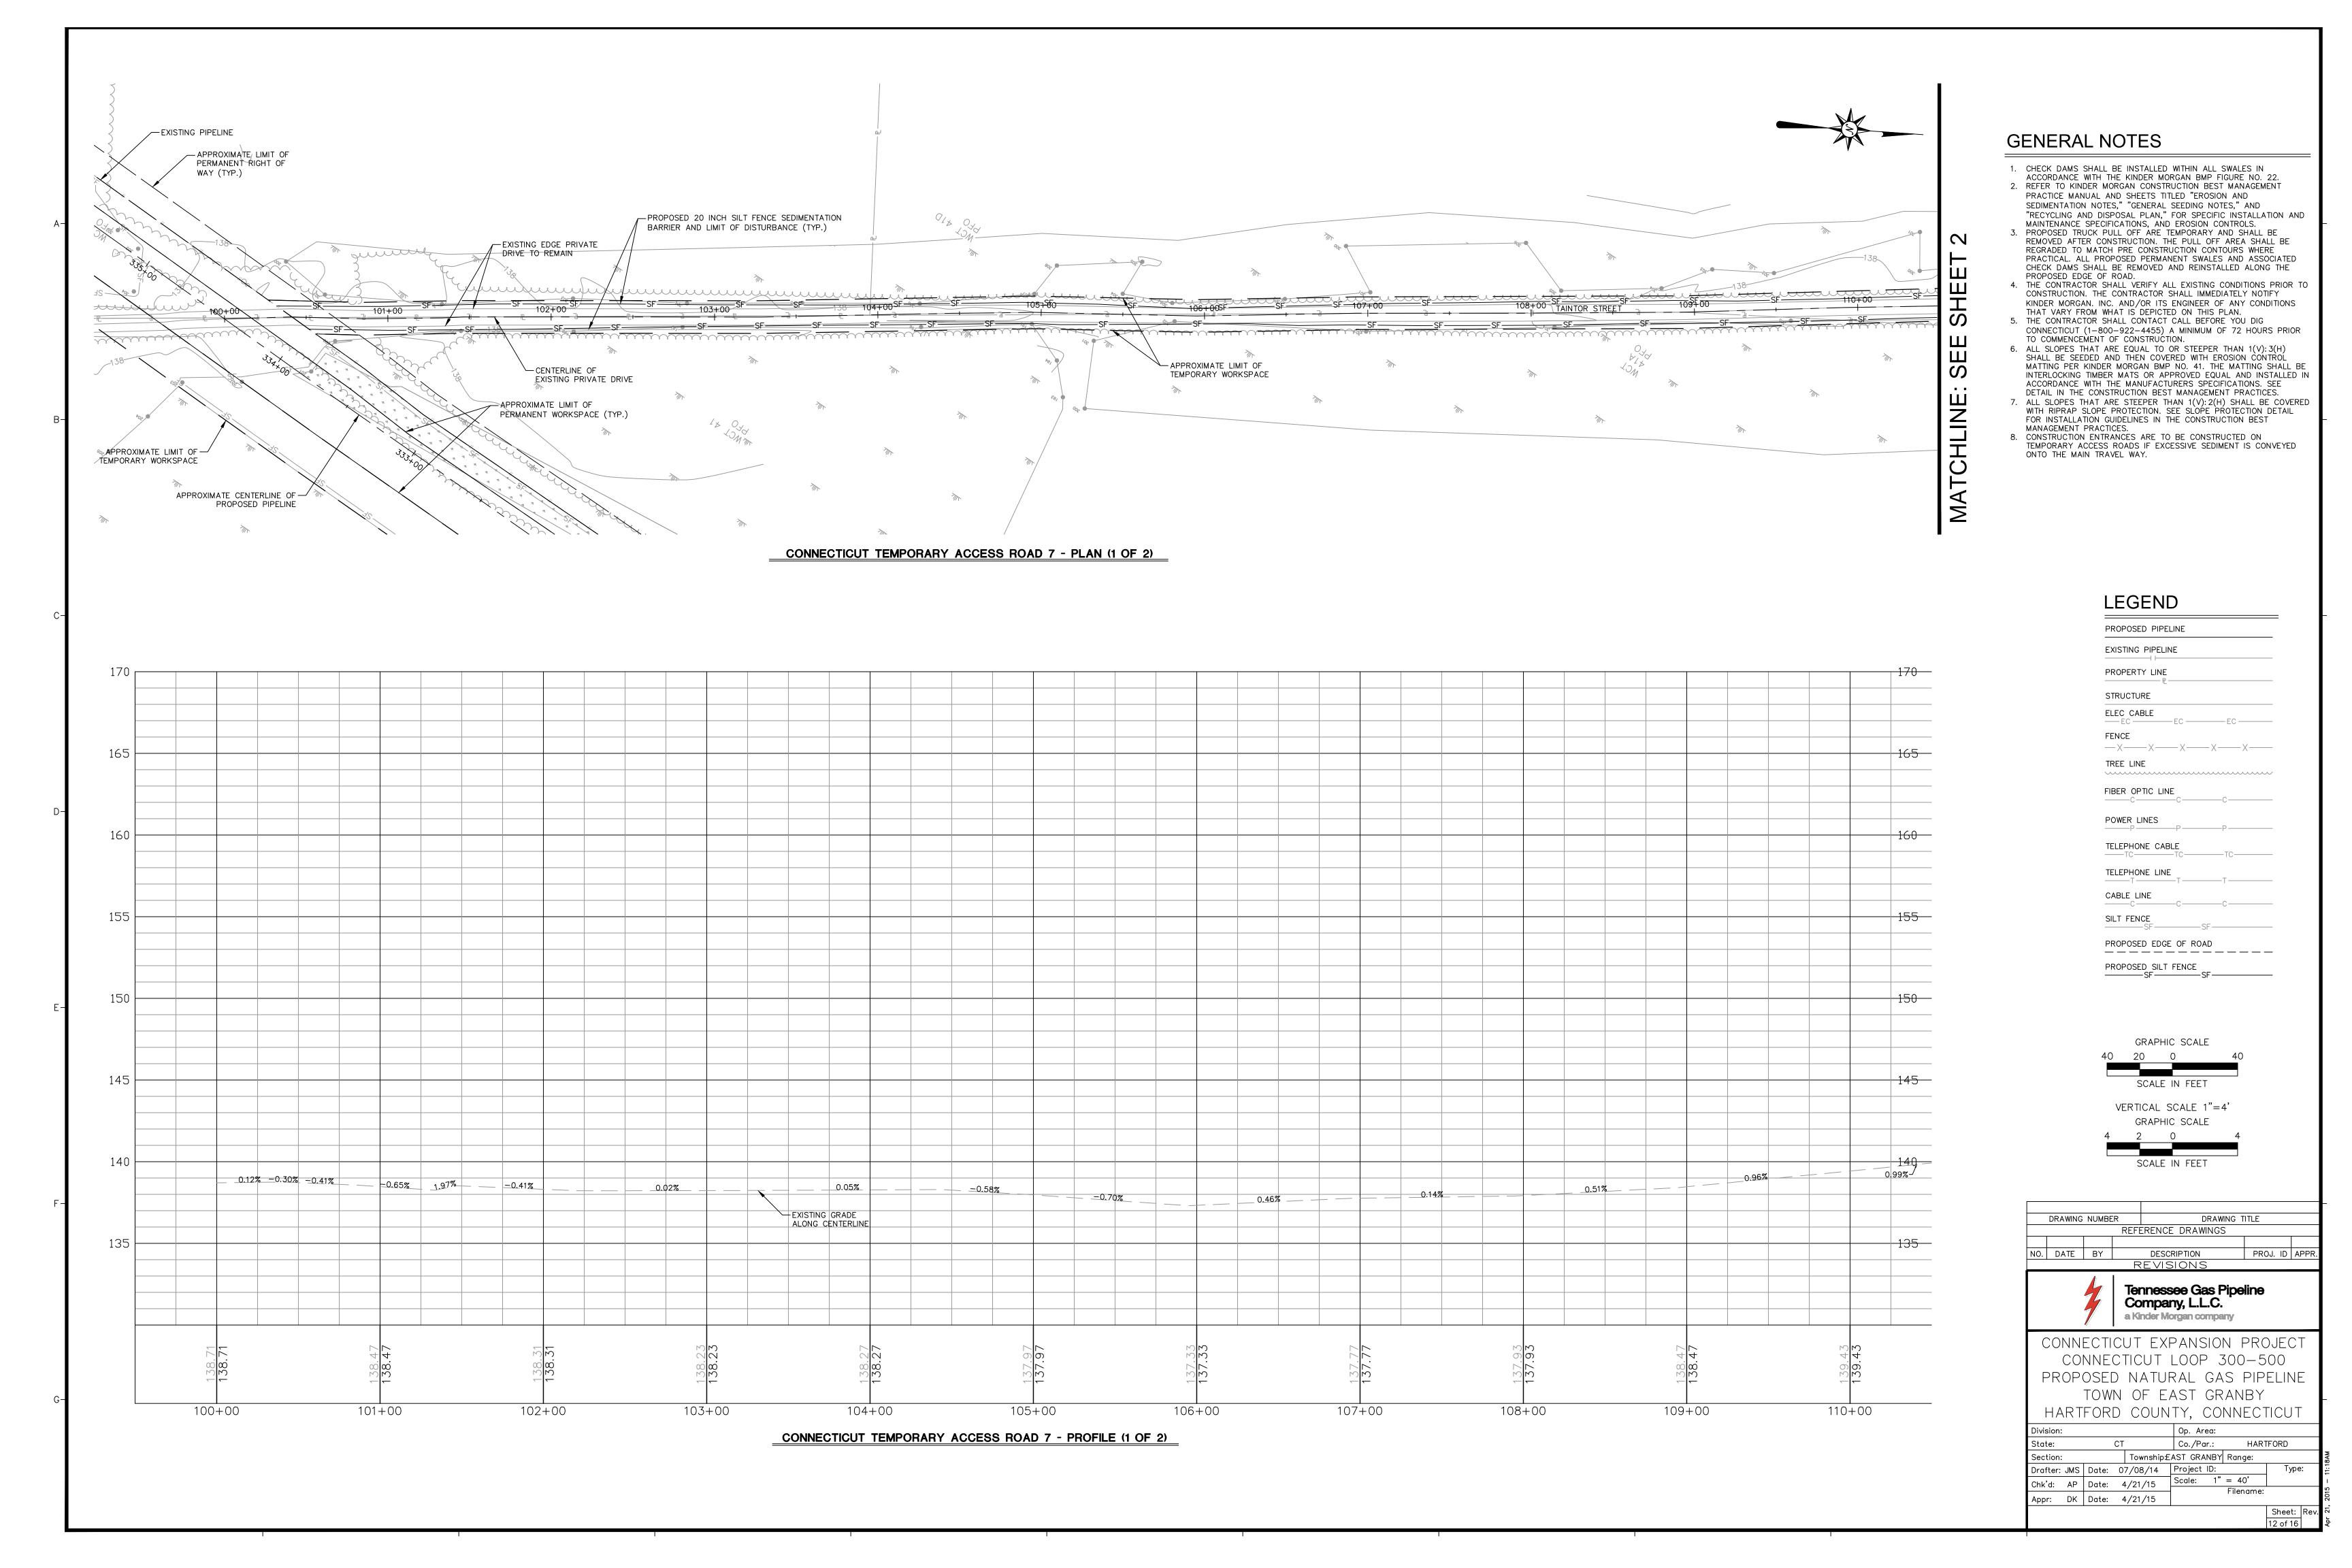

ATCHURING MACHINE LINE OF THE SULFILE STATE AND LINE OF THE SULFIL

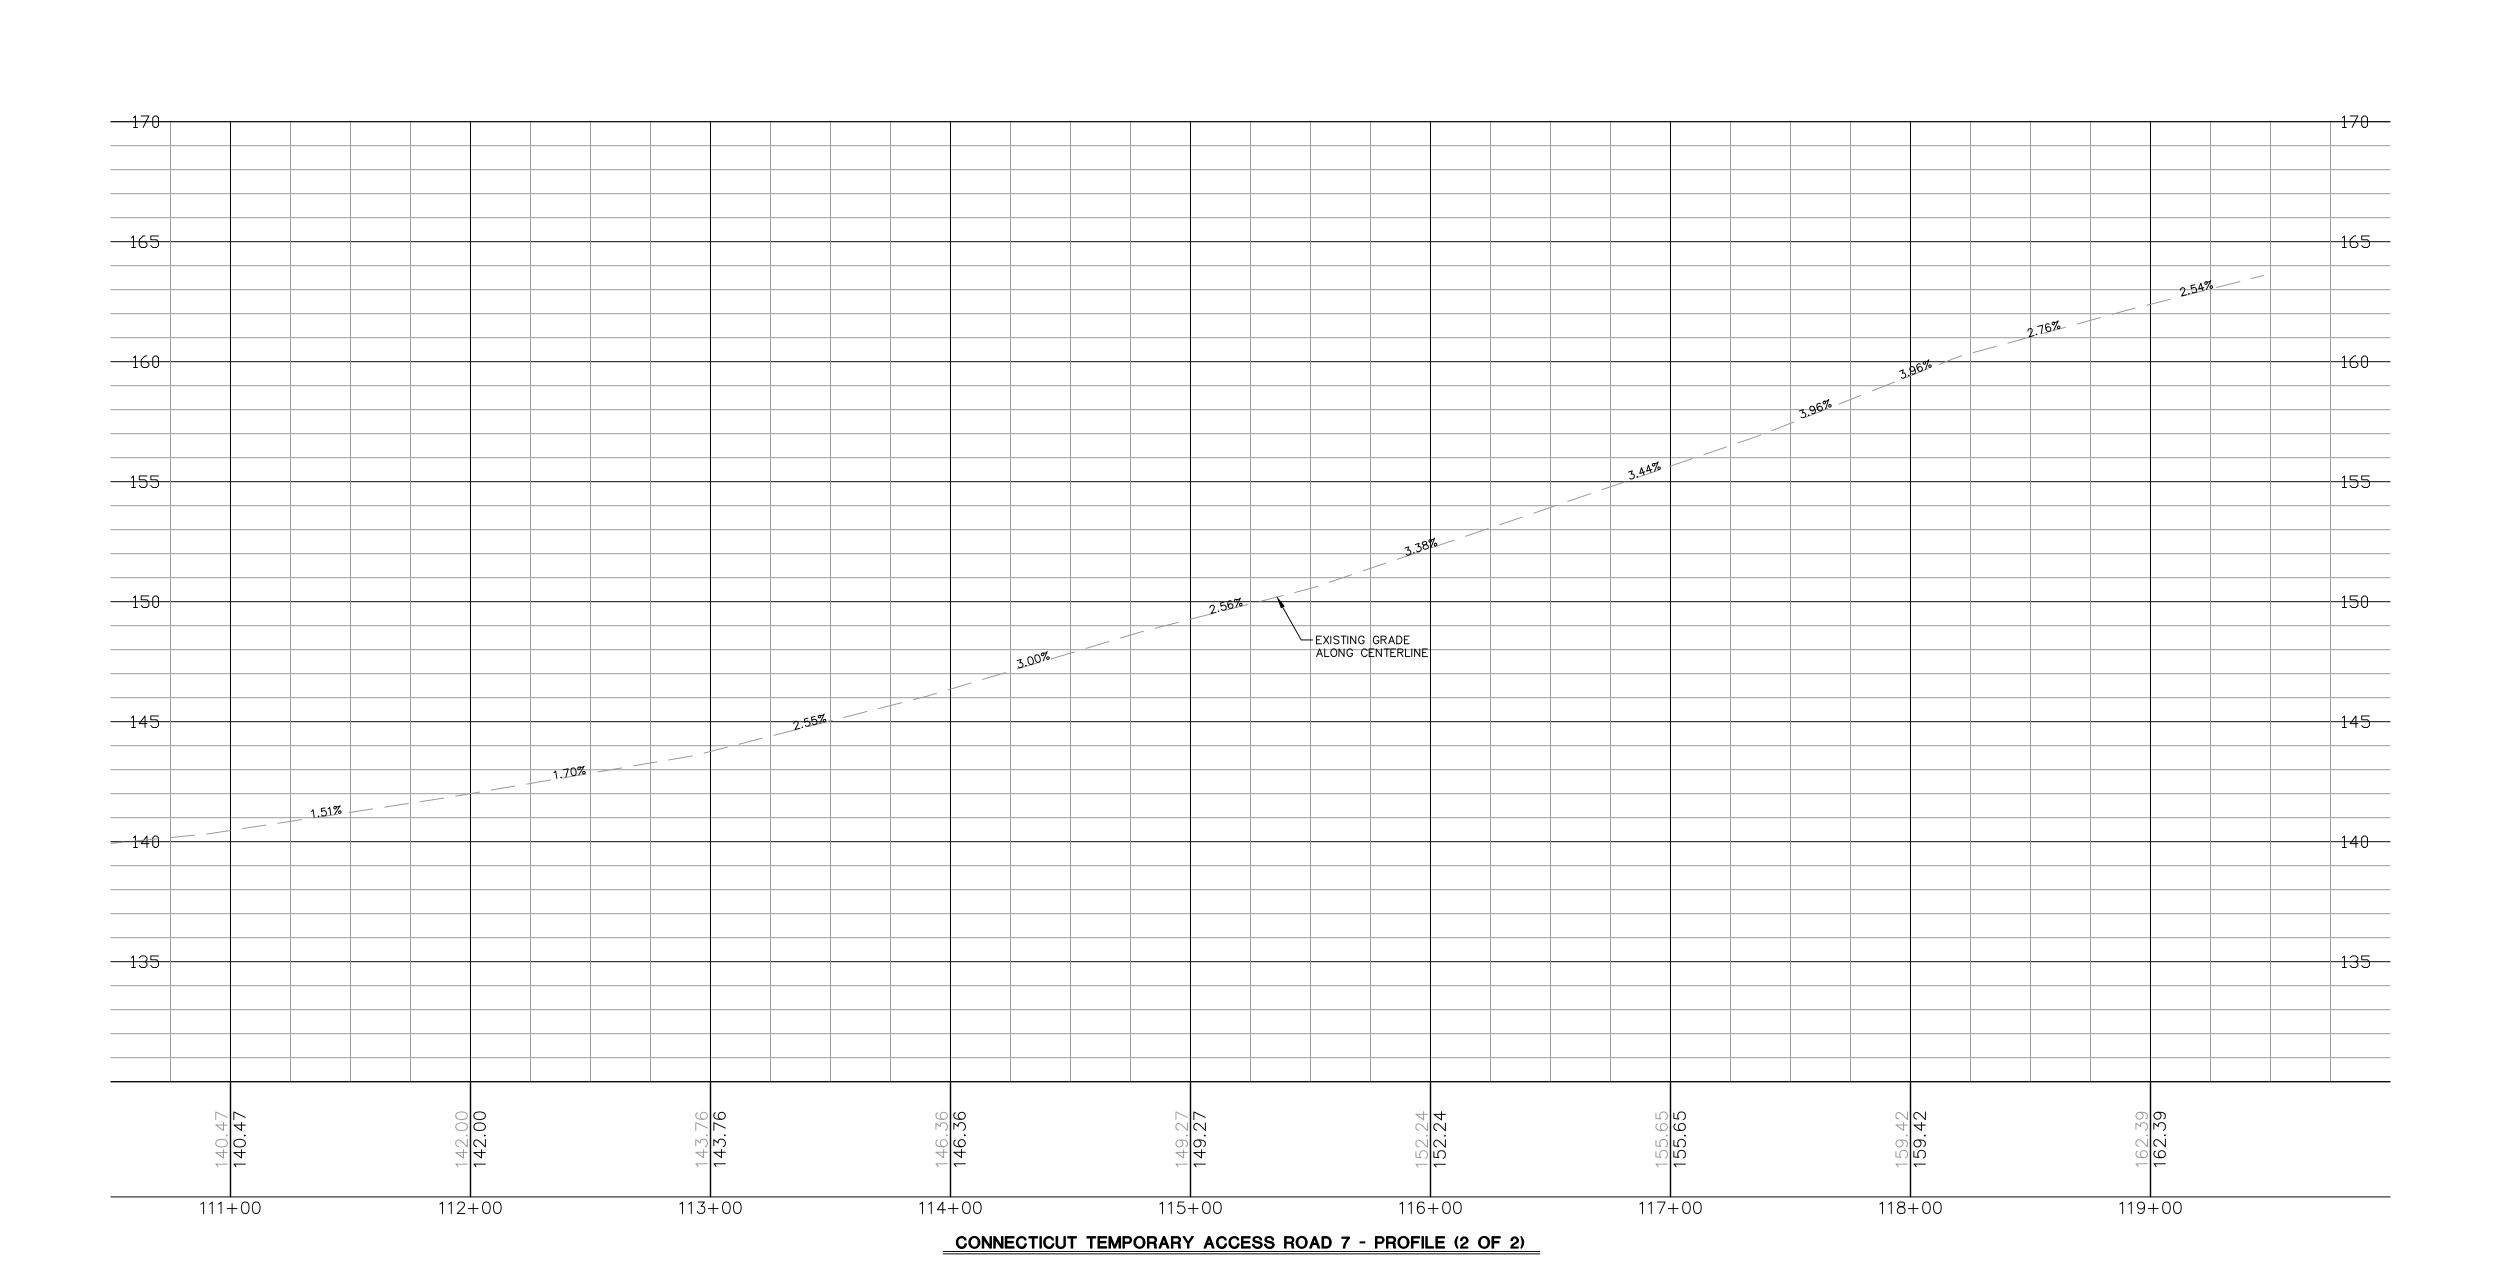

GENERAL NOTES

- CHECK DAMS SHALL BE INSTALLED WITHIN ALL SWALES IN ACCORDANCE WITH THE KINDER MORGAN BMP FIGURE NO. 22.
 REFER TO KINDER MORGAN CONSTRUCTION BEST MANAGEMENT PRACTICE MANUAL AND SHEETS TITLED "EROSION AND SEDIMENTATION NOTES," "GENERAL SEEDING NOTES," AND "RECYCLING AND DISPOSAL PLAN," FOR SPECIFIC INSTALLATION AND
- MAINTENANCE SPECIFICATIONS, AND EROSION CONTROLS.

 3. PROPOSED TRUCK PULL OFF ARE TEMPORARY AND SHALL BE REMOVED AFTER CONSTRUCTION. THE PULL OFF AREA SHALL BE REGRADED TO MATCH PRE CONSTRUCTION CONTOURS WHERE PRACTICAL. ALL PROPOSED PERMANENT SWALES AND ASSOCIATED
- CHECK DAMS SHALL BE REMOVED AND REINSTALLED ALONG THE PROPOSED EDGE OF ROAD.

 4. THE CONTRACTOR SHALL VERIFY ALL EXISTING CONDITIONS PRIOR TO CONSTRUCTION. THE CONTRACTOR SHALL IMMEDIATELY NOTIFY KINDER MORGAN. INC. AND/OR ITS ENGINEER OF ANY CONDITIONS
- THAT VARY FROM WHAT IS DEPICTED ON THIS PLAN.

 5. THE CONTRACTOR SHALL CONTACT CALL BEFORE YOU DIG
 CONNECTICUT (1-800-922-4455) A MINIMUM OF 72 HOURS PRIOR
 TO COMMENCEMENT OF CONSTRUCTION.
- 6. ALL SLOPES THAT ARE EQUAL TO OR STEEPER THAN 1(V): 3(H)
 SHALL BE SEEDED AND THEN COVERED WITH EROSION CONTROL
 MATTING PER KINDER MORGAN BMP NO. 41. THE MATTING SHALL BE
 INTERLOCKING TIMBER MATS OR APPROVED EQUAL AND INSTALLED IN
 ACCORDANCE WITH THE MANUFACTURERS SPECIFICATIONS. SEE
- DETAIL IN THE CONSTRUCTION BEST MANAGEMENT PRACTICES.

 7. ALL SLOPES THAT ARE STEEPER THAN 1(V): 2(H) SHALL BE COVERED WITH RIPRAP SLOPE PROTECTION. SEE SLOPE PROTECTION DETAIL FOR INSTALLATION GUIDELINES IN THE CONSTRUCTION BEST
- MANAGEMENT PRACTICES.

 8. CONSTRUCTION ENTRANCES ARE TO BE CONSTRUCTED ON TEMPORARY ACCESS ROADS IF EXCESSIVE SEDIMENT IS CONVEYED ONTO THE MAIN TRAVEL WAY.

LEGEND

PROPOSED PIPELINE	
EXISTING PIPELINE	
PROPERTY LINE	
P.——	
STRUCTURE TLEC CABLE	
EC — EC — EC —	
ENCE 	
REE LINE	
IBER OPTIC LINE	
POWER LINES	
ELEPHONE CABLE TC-TC-TC-TC-TC-TC-TC-TC-TC-TC-TC-TC-TC-T	
ELEDHONE LINE	
CARLE LINE	
CABLE LINE ———————————————————————————————————	
SILT FENCE SFSFSF	
PROPOSED EDGE OF ROAD	_
PROPOSED SILT FENCE SF——SF———SF———	
31 - 31 -	
ORIZONTAL SCALE 1"=40' GRAPHIC SCALE	
20 0 40	
20415 W 5557	
SCALE IN FEET	
VERTICAL SCALE 1"=4"	
GRAPHIC SCALE 2 0 4	
SCALE IN FEET	


NO.	DATE	BY	DESC	RIPTION	PR(DJ. ID	APPR.		
	REVISIONS								
Tennessee Gas Pipeline Company, L.L.C. a Kinder Morgan company									
F	CO PROP	NNE OSE TOW	CTICUT) NATUI N OF E	PANSION LOOP 300 RAL GAS AST GRAN TY, CONN	0-5 PIP 1BY	00 ELIN	٧E		
Divis	sion:			Op. Area:					
Stat	:e:		СТ	Co./Par.:	HAR	FORD			
Sect	tion:		Township:E	AST GRANBY Rar	nge:				
Draf	ter: JMS	Date:	07/08/14	Project ID:		Ty	/pe:		
Chk'	d: AP	Date:	4/21/15	Scale: 1" = 4					
Аррі	r: DK	Date:	4/21/15	File	name:				


REFERENCE DRAWINGS

DRAWING NUMBER

DRAWING TITLE

Sheet: Rev. 3

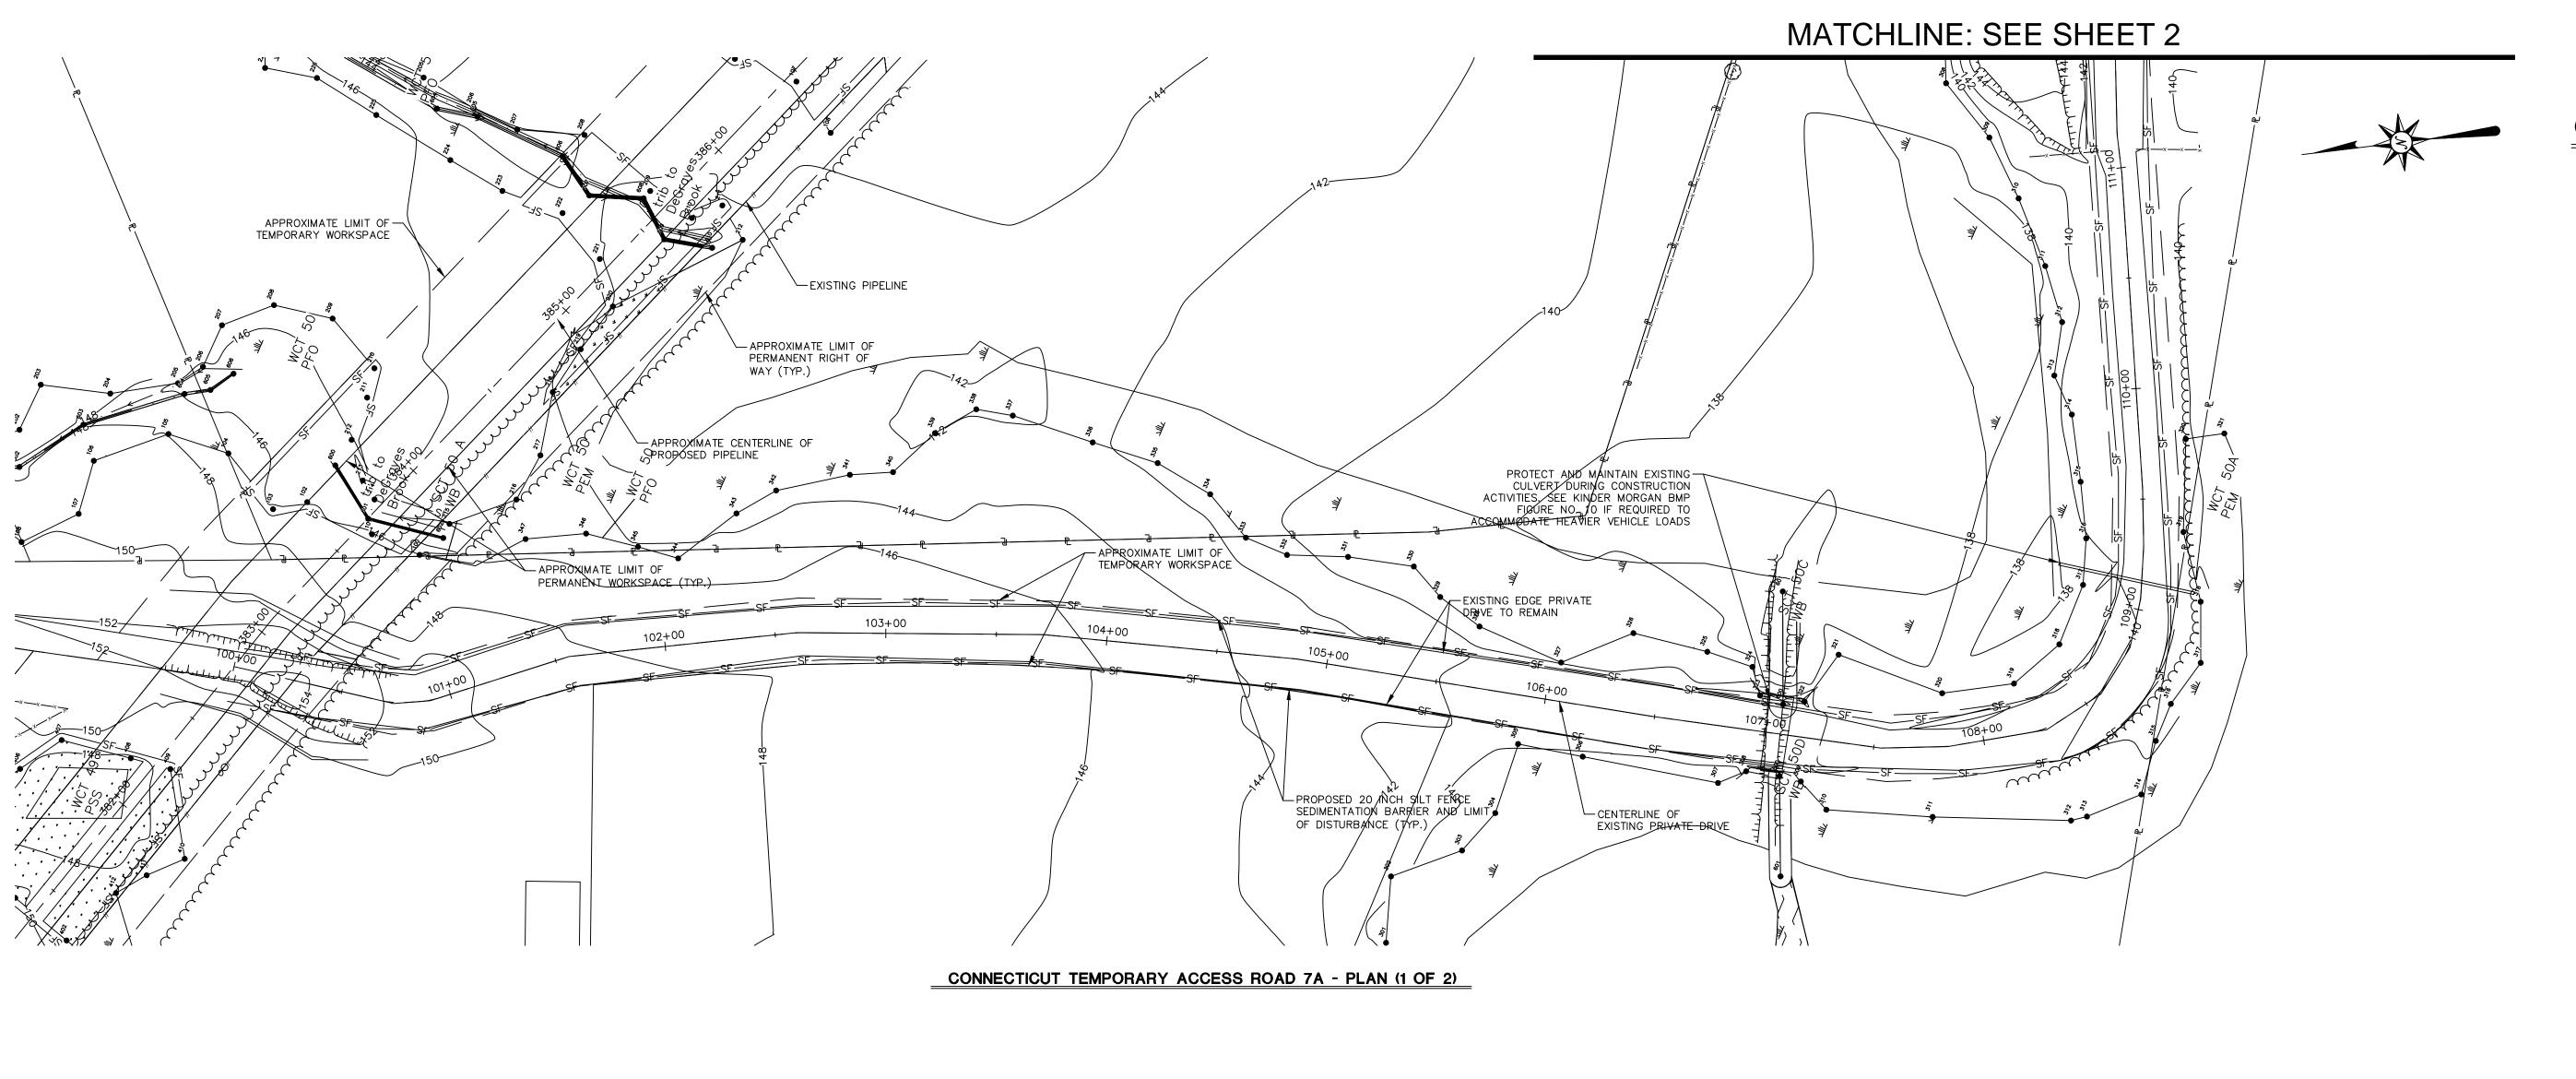

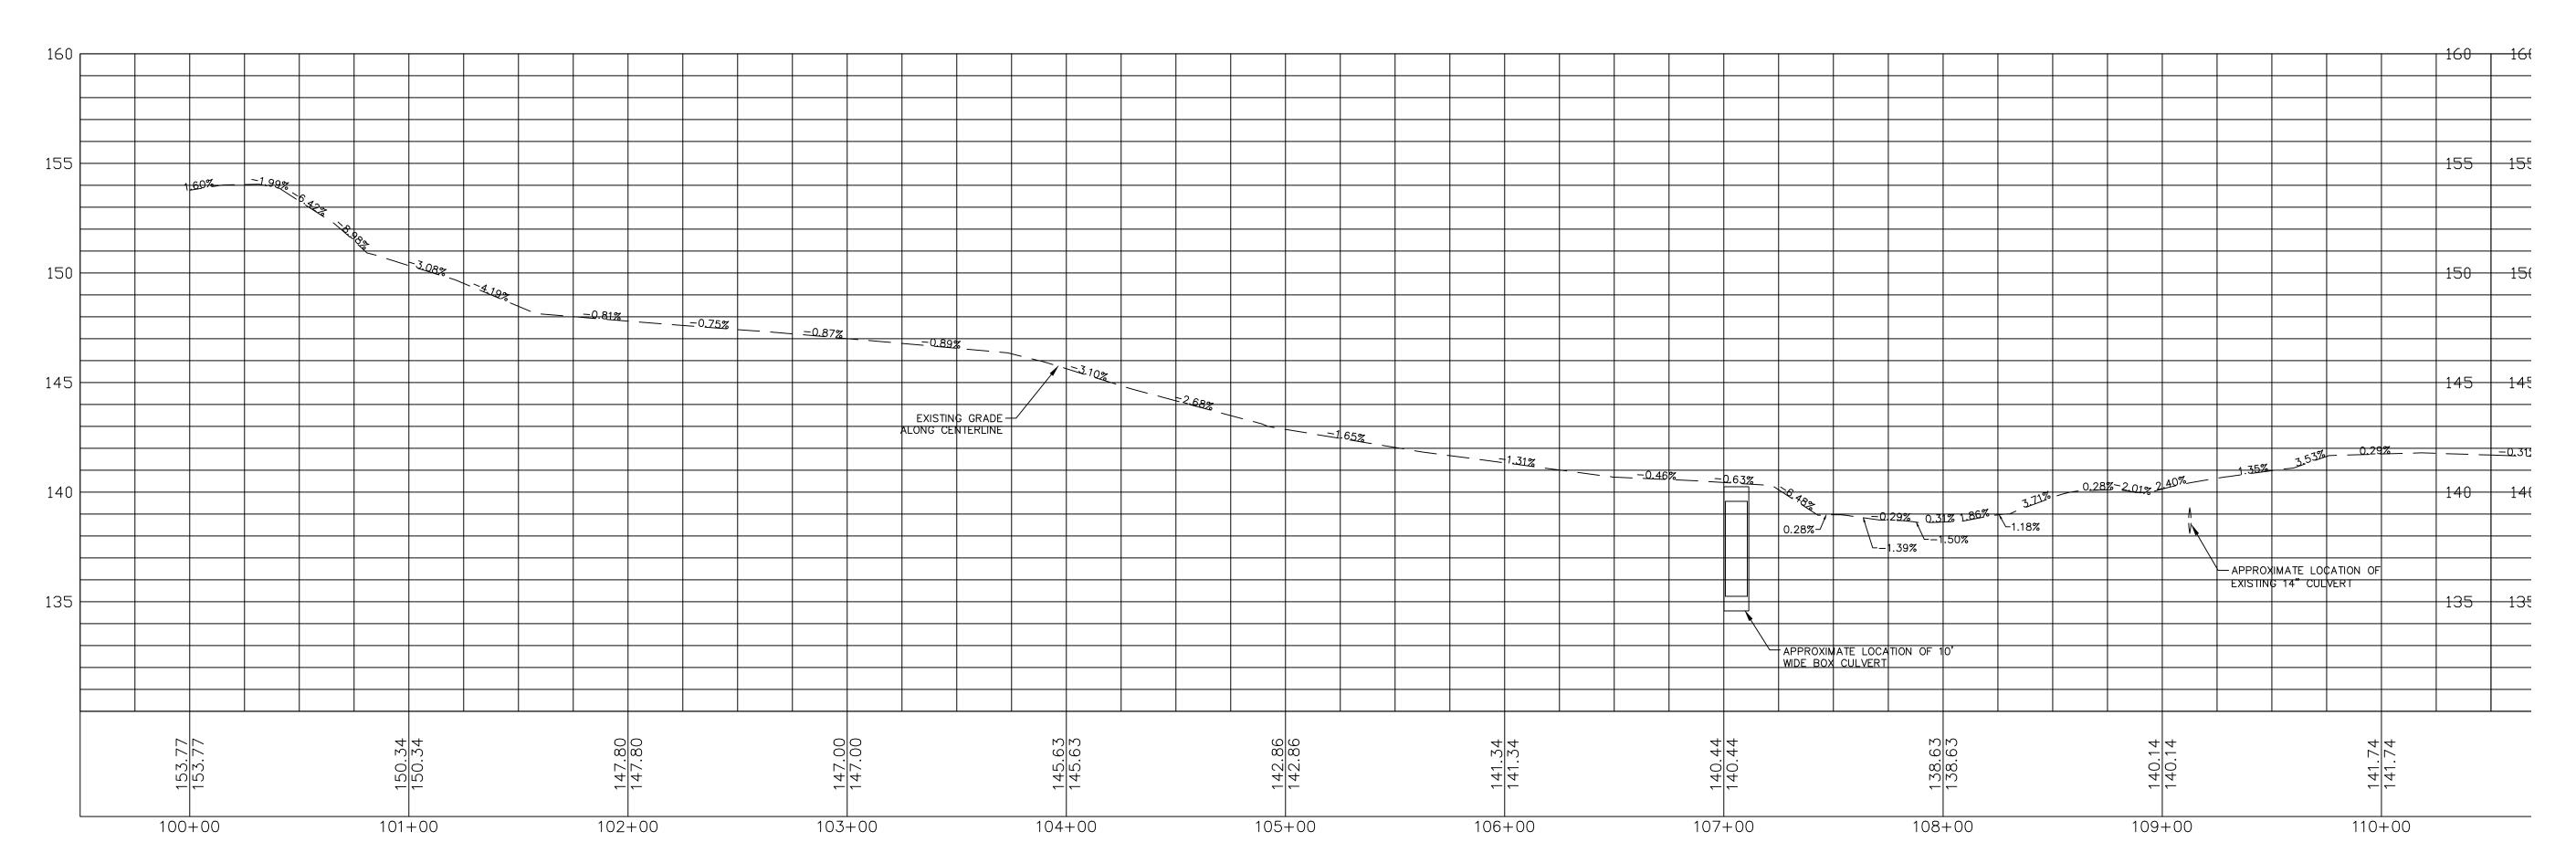

CONNECTICUT TEMPORARY ACCESS ROAD 7A - PROFILE (1 OF 2)

GENERAL NOTES

MANAGEMENT PRACTICES.

- CHECK DAMS SHALL BE INSTALLED WITHIN ALL SWALES IN ACCORDANCE WITH THE KINDER MORGAN BMP FIGURE NO. 22.
 REFER TO KINDER MORGAN CONSTRUCTION BEST MANAGEMENT PRACTICE MANUAL AND SHEETS TITLED "EROSION AND SEDIMENTATION NOTES," "GENERAL SEEDING NOTES," AND "RECYCLING AND DISPOSAL PLAN," FOR SPECIFIC INSTALLATION AND MAINTENANCE SPECIFICATIONS, AND EROSION CONTROLS.
- 3. PROPOSED TRUCK PULL OFF ARE TEMPORARY AND SHALL BE REMOVED AFTER CONSTRUCTION. THE PULL OFF AREA SHALL BE REGRADED TO MATCH PRE CONSTRUCTION CONTOURS WHERE PRACTICAL. ALL PROPOSED PERMANENT SWALES AND ASSOCIATED CHECK DAMS SHALL BE REMOVED AND REINSTALLED ALONG THE PROPOSED EDGE OF ROAD.

 4. THE CONTRACTOR SHALL VERIFY ALL EXISTING CONDITIONS PRIOR TO
- CONSTRUCTION. THE CONTRACTOR SHALL IMMEDIATELY NOTIFY KINDER MORGAN. INC. AND/OR ITS ENGINEER OF ANY CONDITIONS THAT VARY FROM WHAT IS DEPICTED ON THIS PLAN.

 5. THE CONTRACTOR SHALL CONTACT CALL BEFORE YOU DIG CONNECTICUT (1-800-922-4455) A MINIMUM OF 72 HOURS PRIOR TO COMMENCEMENT OF CONSTRUCTION.
- ALL SLOPES THAT ARE EQUAL TO OR STEEPER THAN 1(V): 3(H) SHALL BE SEEDED AND THEN COVERED WITH EROSION CONTROL MATTING PER KINDER MORGAN BMP NO. 41. THE MATTING SHALL BE INTERLOCKING TIMBER MATS OR APPROVED EQUAL AND INSTALLED IN ACCORDANCE WITH THE MANUFACTURERS SPECIFICATIONS. SEE DETAIL IN THE CONSTRUCTION BEST MANAGEMENT PRACTICES.
 ALL SLOPES THAT ARE STEEPER THAN 1(V): 2(H) SHALL BE COVERED WITH RIPRAP SLOPE PROTECTION. SEE SLOPE PROTECTION DETAIL FOR INSTALLATION GUIDELINES IN THE CONSTRUCTION BEST
- 8. CONSTRUCTION ENTRANCES ARE TO BE CONSTRUCTED ON TEMPORARY ACCESS ROADS IF EXCESSIVE SEDIMENT IS CONVEYED ONTO THE MAIN TRAVEL WAY.

LEGEND

PROPOSED PIPELINE

EXISTING PIPELINE

PROPERTY LINE

PROPERTY LINE

ELEC CABLE

ECC EC EC

FENCE

X X X X X X X

TREE LINE

FIBER OPTIC LINE

C C C C

POWER LINES

P P P P

TELEPHONE CABLE

TC TC TC

TELEPHONE LINE

CABLE LINE

CABLE LINE

CABLE LINE

SF SF

PROPOSED EDGE OF ROAD

PROPOSED SILT FENCE

SF SF

HORIZONTAL SCALE 1"=40'
GRAPHIC SCALE

40 20 0 40
SCALE IN FEET

VERTICAL SCALE 1"=4'
GRAPHIC SCALE

4 2 0 4
SCALE IN FEET

DRAWING NUMBER DRAWING TITLE

REFERENCE DRAWINGS

NO. DATE BY DESCRIPTION PRO

REVISIONS

Tennessee Gas Pipeline
Company, L.L.C.
a Kinder Morgan company

CONNECTICUT EXPANSION PROJECT
CONNECTICUT LOOP 300-500
PROPOSED NATURAL GAS PIPELINE
TOWN OF EAST GRANBY

HARTFORD COUNTY, CONNECTICUT

Division:

State:

CT

Co./Par.: HARTFORD

Section:

Township:EAST GRANBY Range:

Drafter: JMS

Date: 07/08/14 Project ID:

Chk'd: AP

Date: 4/21/15

Appr: DK

Date: 4/21/15


Filename:

Sheet: Rev. 3

PROJ. ID APPR.

EMSTING DICE STRYATE. CENTERING OF CHICAGO STRYATE. CENTERIN

CONNECTICUT TEMPORARY ACCESS ROAD 7a - PLAN (2 OF 2)

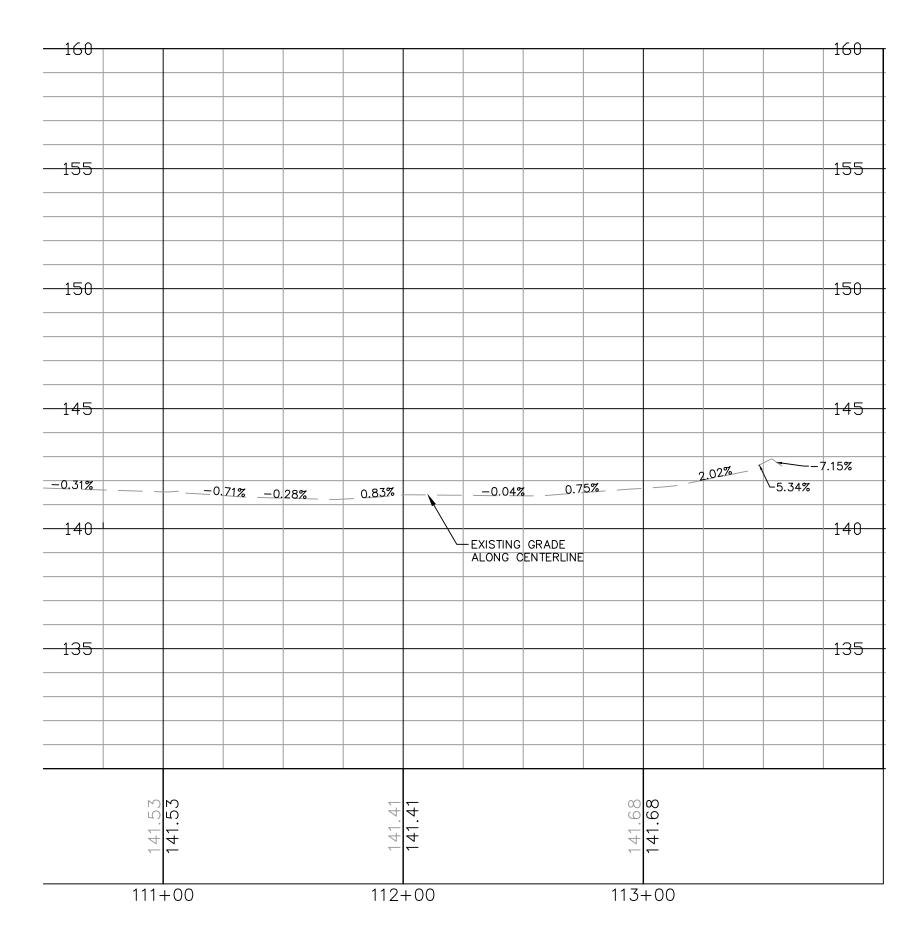

CONNECTICUT TEMPORARY ACCESS ROAD 7a - PROFILE (2 OF 2)


GENERAL NOTES

- CHECK DAMS SHALL BE INSTALLED WITHIN ALL SWALES IN ACCORDANCE WITH THE KINDER MORGAN BMP FIGURE NO. 22.
 REFER TO KINDER MORGAN CONSTRUCTION BEST MANAGEMENT PRACTICE MANUAL AND SHEETS TITLED "EROSION AND SEDIMENTATION NOTES," "GENERAL SEEDING NOTES," AND "PROCESSIONAL PLANT" FOR SPECIFIC INSTALLATION.
- "RECYCLING AND DISPOSAL PLAN," FOR SPECIFIC INSTALLATION AND MAINTENANCE SPECIFICATIONS, AND EROSION CONTROLS.

 3. PROPOSED TRUCK PULL OFF ARE TEMPORARY AND SHALL BE REMOVED AFTER CONSTRUCTION. THE PULL OFF AREA SHALL BE REGRADED TO MATCH PRE CONSTRUCTION CONTOURS WHERE PRACTICAL. ALL PROPOSED PERMANENT SWALES AND ASSOCIATED CHECK DAMS SHALL BE REMOVED AND REINSTALLED ALONG THE PROPOSED EDGE OF ROAD.
- 4. THE CONTRACTOR SHALL VERIFY ALL EXISTING CONDITIONS PRIOR TO CONSTRUCTION. THE CONTRACTOR SHALL IMMEDIATELY NOTIFY KINDER MORGAN. INC. AND/OR ITS ENGINEER OF ANY CONDITIONS THAT VARY FROM WHAT IS DEPICTED ON THIS PLAN.
- 5. THE CONTRACTOR SHALL CONTACT CALL BEFORE YOU DIG CONNECTICUT (1-800-922-4455) A MINIMUM OF 72 HOURS PRIOR TO COMMENCEMENT OF CONSTRUCTION.
- 6. ALL SLOPES THAT ARE EQUAL TO OR STEEPER THAN 1(V): 3(H) SHALL BE SEEDED AND THEN COVERED WITH EROSION CONTROL MATTING PER KINDER MORGAN BMP NO. 41. THE MATTING SHALL BE INTERLOCKING TIMBER MATS OR APPROVED EQUAL AND INSTALLED IN ACCORDANCE WITH THE MANUFACTURERS SPECIFICATIONS. SEE DETAIL IN THE CONSTRUCTION BEST MANAGEMENT PRACTICES.
- 7. ALL SLOPES THAT ARE STEEPER THAN 1(V): 2(H) SHALL BE COVERED WITH RIPRAP SLOPE PROTECTION. SEE SLOPE PROTECTION DETAIL FOR INSTALLATION GUIDELINES IN THE CONSTRUCTION BEST MANAGEMENT PRACTICES.
- 8. CONSTRUCTION ENTRANCES ARE TO BE CONSTRUCTED ON TEMPORARY ACCESS ROADS IF EXCESSIVE SEDIMENT IS CONVEYED ONTO THE MAIN TRAVEL WAY.


LEGEND


EXISTING PIPELINE	
PROPERTY LINE	
STRUCTURE	
ELEC CABLE EC — EC —	
FENCE X X X X X X X X X X X X X X X X X X X	
TREE LINE	
FIBER OPTIC LINE	C
POWER LINES	P
TELEPHONE CABLE	TC
TELEPHONE LINE	т_
CABLE LINE	
SILT FENCE ———————————————————————————————————	
PROPOSED EDGE OF	

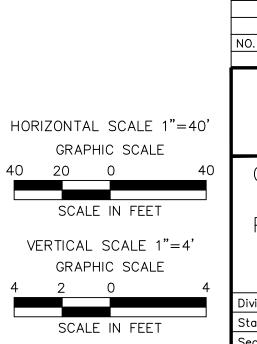

		DRAWING	NUMBE	:R	DRAWING TITLE						
				REFE	ERENCE	E DRA	MINGS				
	NO.	DATE	BY			RIPTION		PRO	J. ID	APP	
1				K	EVIS	SION	5				
)'	Tennessee Gas Pipeline Company, L.L.C. a Kinder Morgan company										
ŀ0]		СО	NNE	CTIC	CUT	LOO	SION F) — 5	00		
4			TOW	ΝΟ	F E	AST	GAS GRAN CONN	ΒY			
<u> </u>	Divis					Op. Area:					
	Stat			CT		Co./F			FORD		
	Sec	tion:		Tov	wnship:E	AST GR		ge:			
	Draf	ter: JMS	Date:	07/08	8/14	Project		-•	Ту	/pe:	
	Chk'	d: AP	Date:	4/21	/15	Scale:	1" = 40				
	Арр	r: DK	Date:	4/21	/15		riien	ame:			

Sheet: Rev. 7

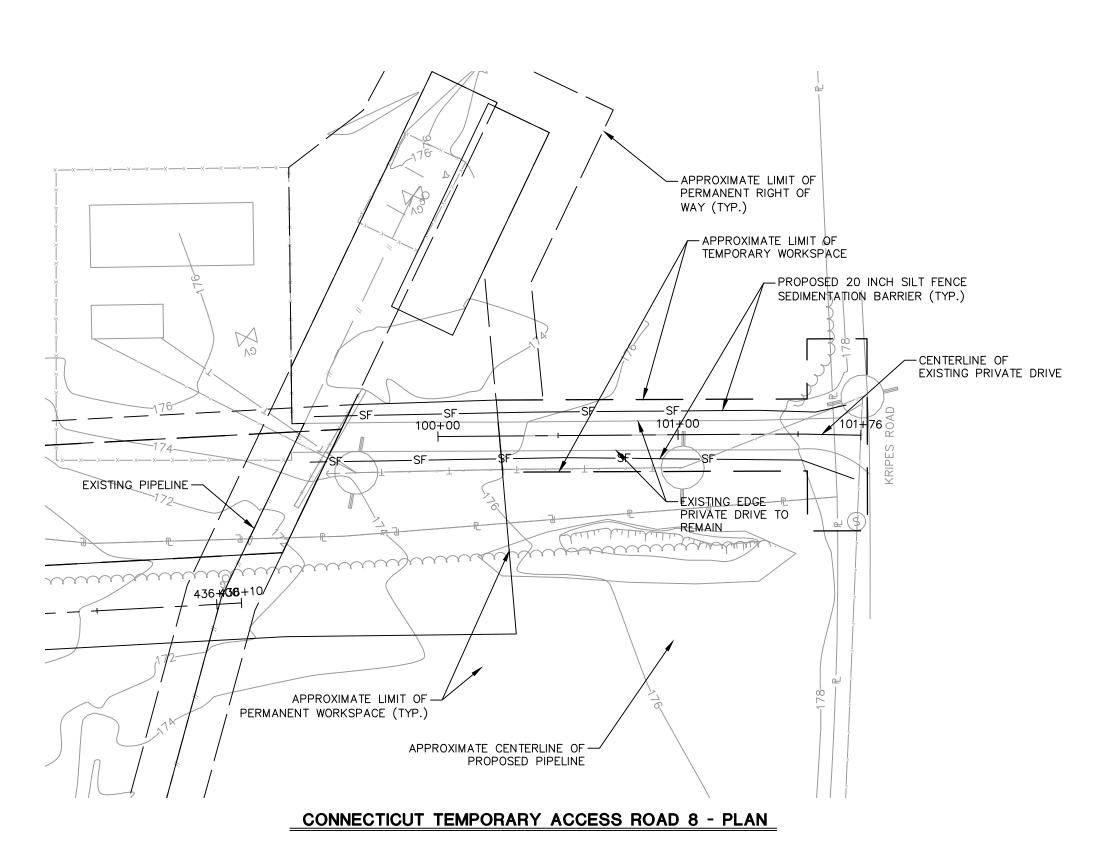

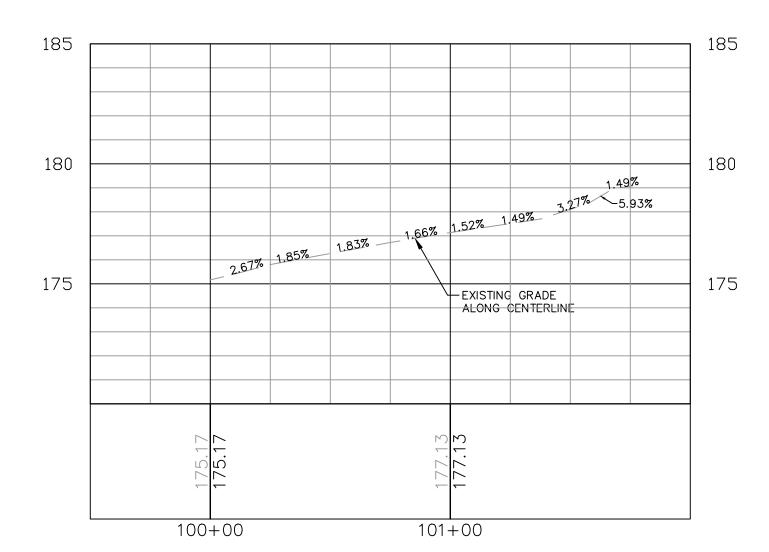

CONNECTICUT TEMPORARY ACCESS ROAD 8 - PROFILE

GENERAL NOTES

- 1. CHECK DAMS SHALL BE INSTALLED WITHIN ALL SWALES IN ACCORDANCE WITH THE KINDER MORGAN BMP FIGURE NO. 22.

 2. REFER TO KINDER MORGAN CONSTRUCTION BEST MANAGEMENT PRACTICE MANUAL AND SHEETS TITLED "EROSION AND SEDIMENTATION NOTES," "GENERAL SEEDING NOTES," AND "RECYCLING AND DISPOSAL PLAN," FOR SPECIFIC INSTALLATION AND MAINTENANCE SPECIFICATIONS AND EROSION CONTROLS.
- MAINTENANCE SPECIFICATIONS, AND EROSION CONTROLS.

 3. PROPOSED TRUCK PULL OFF ARE TEMPORARY AND SHALL BE REMOVED AFTER CONSTRUCTION. THE PULL OFF AREA SHALL BE REGRADED TO MATCH PRE CONSTRUCTION CONTOURS WHERE PRACTICAL. ALL PROPOSED PERMANENT SWALES AND ASSOCIATED CHECK DAMS SHALL BE REMOVED AND REINSTALLED ALONG THE PROPOSED EDGE OF ROAD.
- 4. THE CONTRACTOR SHALL VERIFY ALL EXISTING CONDITIONS PRIOR TO CONSTRUCTION. THE CONTRACTOR SHALL IMMEDIATELY NOTIFY KINDER MORGAN. INC. AND/OR ITS ENGINEER OF ANY CONDITIONS THAT VARY FROM WHAT IS DEPICTED ON THIS PLAN.
- 5. THE CONTRACTOR SHALL CONTACT CALL BEFORE YOU DIG CONNECTICUT (1-800-922-4455) A MINIMUM OF 72 HOURS PRIOR TO COMMENCEMENT OF CONSTRUCTION.
- 6. ALL SLOPES THAT ARE EQUAL TO OR STEEPER THAN 1(V): 3(H)
 SHALL BE SEEDED AND THEN COVERED WITH EROSION CONTROL
 MATTING PER KINDER MORGAN BMP NO. 41. THE MATTING SHALL BE
 INTERLOCKING TIMBER MATS OR APPROVED EQUAL AND INSTALLED IN
 ACCORDANCE WITH THE MANUFACTURERS SPECIFICATIONS. SEE
 DETAIL IN THE CONSTRUCTION BEST MANAGEMENT PRACTICES.
- 7. ALL SLOPES THAT ARE STEEPER THAN 1(V): 2(H) SHALL BE COVERED WITH RIPRAP SLOPE PROTECTION. SEE SLOPE PROTECTION DETAIL FOR INSTALLATION GUIDELINES IN THE CONSTRUCTION BEST
- MANAGEMENT PRACTICES.

 8. CONSTRUCTION ENTRANCES ARE TO BE CONSTRUCTED ON TEMPORARY ACCESS ROADS IF EXCESSIVE SEDIMENT IS CONVEYED ONTO THE MAIN TRAVEL WAY.

LEGEND PROPOSED PIPELINE EXISTING PIPELINE PROPERTY LINE STRUCTURE **FENCE** -X-X-X-X-X-X-TREE LINE FIBER OPTIC LINE POWER LINES TELEPHONE CABLE TELEPHONE LINE CABLE LINE SILT FENCE PROPOSED EDGE OF ROAD _____

